

6 TAFT COURT LANDSCAPE IMPROVEMENTS PHASE 1

6 TAFT COURT ROCKVILLE, MD
20850

DELTA PROJECT NO. 2019.331.004
12/23/2021(PERMIT REVISION 04/01/2022)
IFB #08-22

INDEX OF DRAWINGS

CITY OF ROCKVILLE COMMENTS

LANDSCAPE ARCHITECTURAL


G-001	TITLE SHEET
L-002	GENERAL NOTES & ABBREVIATIONS
L-120	EXISTING CONDITIONS PLAN
L-140	DEMOLITION PLAN BREAK AREA AND LOADING DOCK
L-141	LAYOUT & GRADING PLAN BREAK AREA & LOADING DOCK
L-150	PLANTING PLAN
L-500	SITE DETAILS
L-501	SITE DETAILS
L-502	LOADING DOCK DETAILS

ARCHITECT/ENGINEER



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PROJECT LOCATION

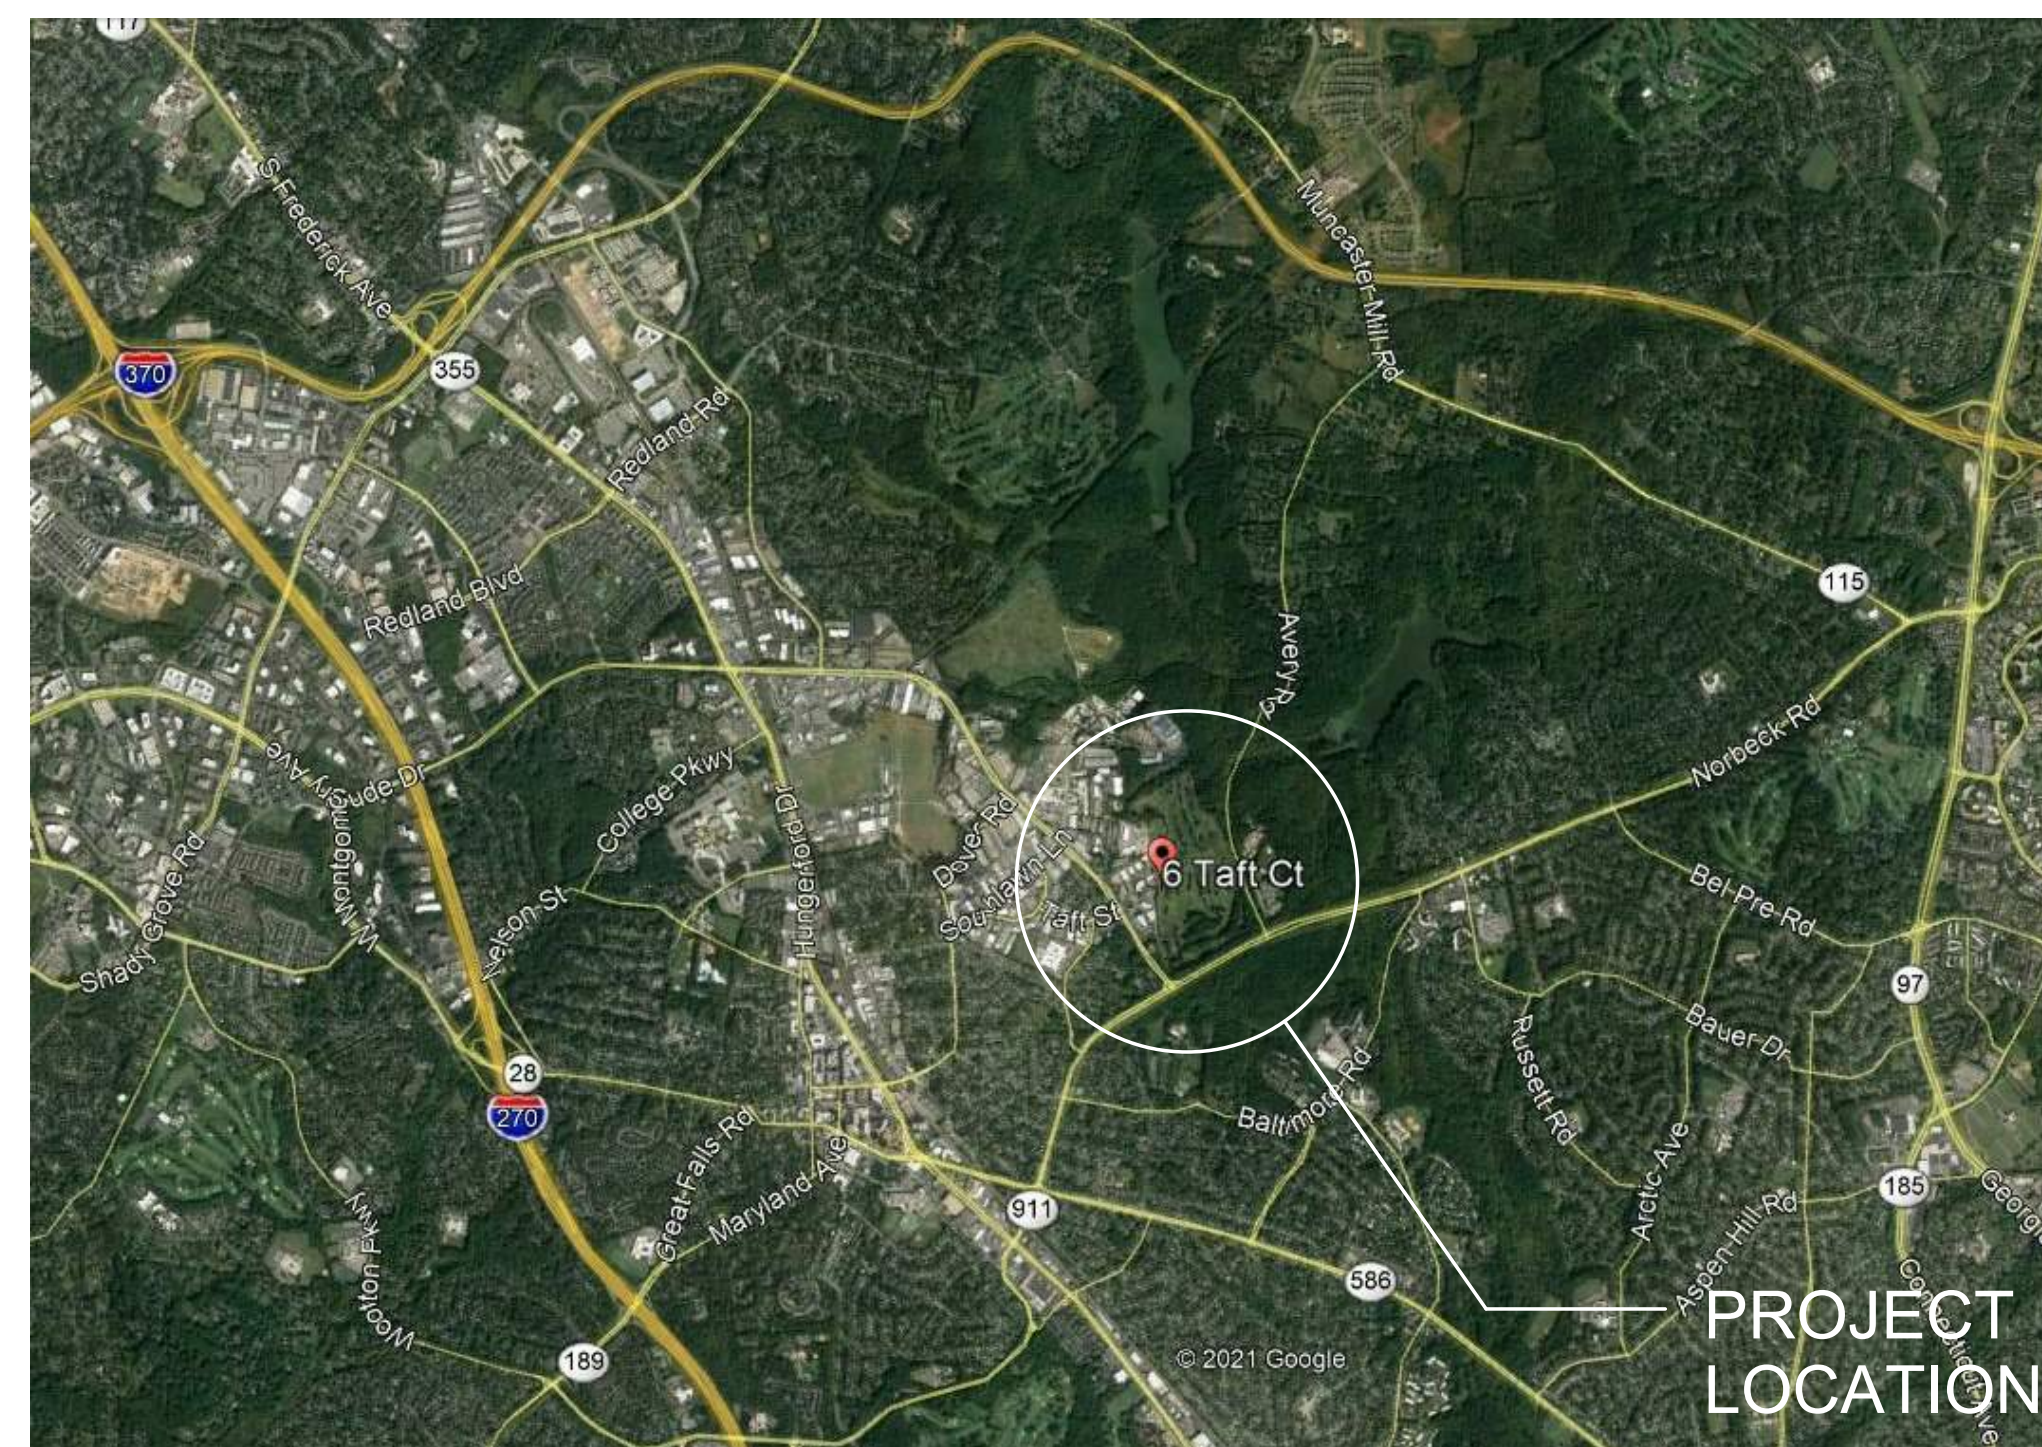

OWNER



CITY OF ROCKVILLE
6 TAFT COURT
ROCKVILLE, MD 20850

APPROVED BY CITY OF ROCKVILLE, MD
DIRECTOR OF PUBLIC WORKS DATE
SEPERATE BUILDING PERMIT(S) FROM INSPECTION
SERVICES DIVISION ARE REQUIRED FOR ON-SITE
CONSTRUCTION

G-001

GENERAL PROJECT NOTES

- 1. LANDSCAPE ARCHITECT ACCEPTS NO RESPONSIBILITY FOR DAMAGE TO PROPERTY OR PERSONAL INJURY OCCURRING DURING CONSTRUCTION...

GENERAL EXISTING CONDITIONS NOTES

- 1. EXISTING CONDITIONS PLAN BASED ON SURVEY DATA PROVIDED BY KIM ENGINEERING, INC. 19634 CLUB HOUSE ROAD, SUITE 310 GAITHERSBURG, MARYLAND 20886 (301-337-6734) AND TOPOGRAPHIC AND ELEVATION DATA COLLECTED BY DELTA ENGINEERS, ARCHITECTS, LAND SURVEYORS, & LANDSCAPE ARCHITECTS DPC AND FIELD NOTES AND MEASUREMENTS BY LANDSCAPE ARCHITECT ON 01.10.2022.

GENERAL SITE ACCESS AND PUBLIC USE NOTES

- 1. CONTRACTOR SHALL STAGE & SCHEDULE CONSTRUCTION TO ACCOMMODATE UNOBTSTRUCTED AND SAFE PUBLIC ACCESS TO ADJACENT BUILDING ENTRANCES AT ALL REGULAR OPERATING TIMES.

GENERAL STOCKPILE NOTES

- 1. STOCKPILED MATERIAL SHALL BE COVERED WITH TARPES AND/OR STRAW IMMEDIATELY FOLLOWING COMPLETION OF EXCAVATION EFFORT.

GENERAL DEMOLITION NOTES

- 1. BRUSH REMOVAL INCLUDES SHRUBS, VINES, AND DEAD WOOD AS INDICATED. ALL REMOVALS SHALL BE DONE BY HAND AS MUCH AS POSSIBLE TO MINIMIZE DAMAGE TO TREE ROOTS.

GENERAL UTILITY NOTES

- 1. ALL ELECTRICAL WORK SHALL BE COMPLETED IN ACCORDANCE WITH STATE AND LOCAL CODES.

GENERAL GRADING & DRAINAGE NOTES

- 1. CONTRACTOR RESPONSIBLE FOR VERIFYING EXISTING TOPOGRAPHY WITHIN THE PROJECT LIMITS. INFORM LANDSCAPE ARCHITECT IMMEDIATELY IF DISCREPANCIES WITH EXISTING CONDITIONS TOPOGRAPHY IS FOUND.

GENERAL E&SC NOTES AND SEEDING NOTES

- 1. SILT FENCES AND OTHER FORMS OF EROSION CONTROL MUST BE INSTALLED PRIOR TO THE START OF WORK AND SHALL BE MAINTAINED UNTIL ALL DISTURBED AREAS ARE STABILIZED.

NEWSOME TRIO MIX OR EQUAL: 85% TALL FESCUE 10% KENTUCKY BLUEGRASS 5% PERENNIAL RYEGRASS

SEED SOURCES: (SEED SOURCES FOR ABOVE MIXES OR SPECIES INCLUDE BUT ARE NOT LIMITED TO) (LAWN MIX)

- 8. LABELS MUST SHOW THE PERCENTAGE BY WEIGHT AND ALL PARTICULARS OF EACH INGREDIENT IN THE MIXTURE.

E&SC MAINTENANCE NOTES

- 1. ALL EROSION AND SEDIMENT CONTROL PRACTICES WILL BE CHECKED FOR STABILITY AND OPERATION AT LEAST EVERY 7 CALENDAR DAYS AND WITHIN 24 HOURS OF THE END OF A STORM EVENT OF 0.5 INCHES OR GREATER.

SOIL PROFILE REBUILDING SPECIFICATION

SOURCE: CITY OF ROCKVILLE, MARYLAND NOVEMBER 2019

SPECIFICATION FOR RESTORATION OF GRADED AND COMPACTED SOILS THAT WILL BE VEGETATED BASED ON SPECIFICATIONS DEVELOPED AT VIRGINIA POLYTECHNIC INSTITUTE, DEPARTMENT OF HORTICULTURE

1. PURPOSE AND DESCRIPTION

1.1 PURPOSE: SOIL PROFILE REBUILDING IS AN APPROPRIATE SOIL RESTORATION TECHNIQUE FOR SITES WHERE TOPSOIL HAS BEEN COMPLETELY OR PARTIALLY REMOVED AND SUBSOIL LAYERS HAVE BEEN COMPACTED.

1.2 DESCRIPTION OF PROCEDURE

THE PROCEDURE INCLUDES A SUBSOILING PROCEDURE, ADDITION OF ORGANIC MATTER IN THE FORM OF COMPOST, REPLACEMENT OR ADDITION OF TOPSOIL, AND SUBSEQUENT PLANTING WITH WOODY PLANTS.

1.3 EXPECTED OUTCOMES

SOIL PROFILE REBUILDING MAY IMPROVE VEGETATION ESTABLISHMENT, INCREASE TREE GROWTH RATES, INCREASE SOIL PERMEABILITY, ENHANCE FORMATION OF AGGREGATES IN THE SUBSOIL, AND ENHANCE LONG-TERM SOIL CARBON STORAGE.

2. PROCEDURE

2.1 LOCATION: PROFILE REBUILDING SHALL OCCUR ON ALL SOIL AREAS THAT ARE TO BE VEGETATED THAT HAVE BEEN DISTURBED BY TRAFFICKING OR GRADING DURING CONSTRUCTION.

2.2 SEQUENCING

PROFILE REBUILDING SHALL OCCUR AFTER SITE DISTURBANCE IS COMPLETE, INCLUDING ALL VEHICLE AND EQUIPMENT TRAFFICKING, BUT BEFORE REPLACEMENT OF TOPSOIL.

2.3 REMOVE FOREIGN MATERIALS

REMOVE ALL FOREIGN MATERIALS RESULTING FROM CONSTRUCTION OPERATIONS, INCLUDING OIL DRIPPINGS, STONE, GRAVEL, AND OTHER CONSTRUCTION MATERIALS FROM THE EXISTING SOIL SURFACE.

2.4 APPLICATION OF COMPOST

SPREAD MATURE, STABLE COMPOST TO A 4 INCH DEPTH OVER COMPACTED SUBSOIL (SEE SECTION 3, DEFINITIONS FOR DEFINITION OF COMPOST).

2.5 SUBSOILING

SUBSOILING MAY BE PERFORMED WHEN SOIL IS NEITHER WET NOR DRY. IF A SHOVEL CANNOT BE FORCED INTO THE SOIL, IT IS TOO DRY. IF THE SURFACE IS STICKY OR MUDDY, IT IS TOO WET.

GENERAL PLANTING NOTES

- 1. ANY SUBSTITUTIONS OF PLANT MATERIALS MUST BE APPROVED BY LANDSCAPE ARCHITECT BEFORE ORDERING & INSTALLATION.

PLANTING MAINTENANCE AGREEMENT

- 1. FOR ALL MAINTENANCE REQUIREMENTS, IF CONTRACTOR DOES NOT PERFORM WORK, ALTERNATIVE MEANS WILL BE PURSUED BY THE OWNER AT THE EXPENSE OF THE CONTRACTOR.

GENERAL LAYOUT NOTES

- 1. CONTRACTOR TO VERIFY ALL DIMENSIONS IN THE FIELD AND REPORT ANY DISCREPANCIES IMMEDIATELY. FIELD CHANGES MUST BE APPROVED LANDSCAPE ARCHITECT OR CONSTRUCTION MANAGER.

3.2 COMPOST: COMPOST SHALL BE COMPOSED OF LEAVES, YARD WASTE, OR FOOD WASTE. BIOSOLID-BASED COMPOSTS SHALL NOT BE USED.

3.3 SEVERELY DEGRADED SOIL: SOIL SHALL BE CONSIDERED SEVERELY DEGRADED IF GRADE WAS LOWERED OR RAISED MORE THAN 14 INCHES OR SOIL WAS COMPACTED IN LIFTS REGARDLESS OF THE FINAL GRADE OR WAS USED AS A STAGING AREA FOR CONSTRUCTION MATERIALS.

- 1. FREE OF WEED SEEDS. 2. FREE OF HEAVY METALS OR OTHER DELETERIOUS CONTAMINANTS. 3. HAVE A SOLUBLE SALT CONTENT WHICH IS LESS THAN 3 DS/M.

4. SUBMITTALS

- 4.1 SOIL MAP: A SOIL MAP INDICATING SOIL AREAS TO BE PROTECTED AND THOSE TO BE RESTORED VIA SOIL PROFILE REBUILDING SHALL BE SUBMITTED BY THE CONTRACTOR FOR APPROVAL TO THE CITY FORESTRY DIVISION BEFORE CONSTRUCTION BEGINS.

4.2 COMPOST

A COMPOST SAMPLE WITH ANALYSIS CERTIFYING IT IS STABLE, MATURE, FROM ACCEPTABLE FEEDSTOCKS AND FREE OF CONTAMINANTS AND WEED SEEDS SHALL BE SUBMITTED FOR APPROVAL TO THE CITY FORESTRY DIVISION BEFORE COMPOST IS APPLIED TO THE SOIL.

4.3 TOPSOIL

A TOPSOIL SAMPLE WITH ANALYSIS FROM A CERTIFIED TESTING LABORATORY AND VERIFICATION OF SOURCE SHALL BE SUBMITTED FOR APPROVAL TO BY THE CITY FORESTRY DIVISION BEFORE APPLICATION.

5. REFERENCES & PERMISSIONS

USE OF THIS SPECIFICATION HAS BEEN DOCUMENTED TO INCREASE TREE CANOPY AND SOIL CARBON STORES AND REDUCE CARBON FOOTPRINT. SEE WWW.URBANFORESTRY.FREC.VT.EDU/SRES FOR MORE INFORMATION.

SOIL PROFILE REBUILDING SPECIFICATION BY SUSAN DAY ET AL. IS LICENSED UNDER A CREATIVE COMMONS ATTRIBUTION-NONCOMMERCIAL 3.0 UNITED STATES LICENSE.

- 1. BE FRIABLE AND WELL DRAINED 2. HAVE A PH BETWEEN 5.5-7. 3. HAVE AN ORGANIC MATTER CONTENT BETWEEN 4-6%. 4. HAVE LOW SALINITY AS INDICATED BY A SOLUBLE SALT CONTENT WHICH IS LESS THAN 3 DS/M

Table with 2 columns: ABBREVIATIONS (LANDSCAPE) and corresponding symbols. Includes entries like @ AT, & AND, ALT. ALTERNATE, APPROX. APPROXIMATELY, APRVD. APPROVED, B&B BALLED & BURLAPPED, BOB (or) BB BOTTOM OF BANK, etc.



APPROVED BY CITY OF ROCKVILLE, MD. DIRECTOR OF PUBLIC WORKS DATE SEPARATE BUILDING PERMITS FROM INSPECTION SERVICES DIVISION ARE REQUIRED FOR ON-SITE CONSTRUCTION

Key Plan

SCALE: X" = XX' X"

Table with 3 columns: No., Revision, Date. Includes a revision entry for Project Name.

CITY OF ROCKVILLE 6 TAFT COURT RENOVATION

ROCKVILLE MARYLAND



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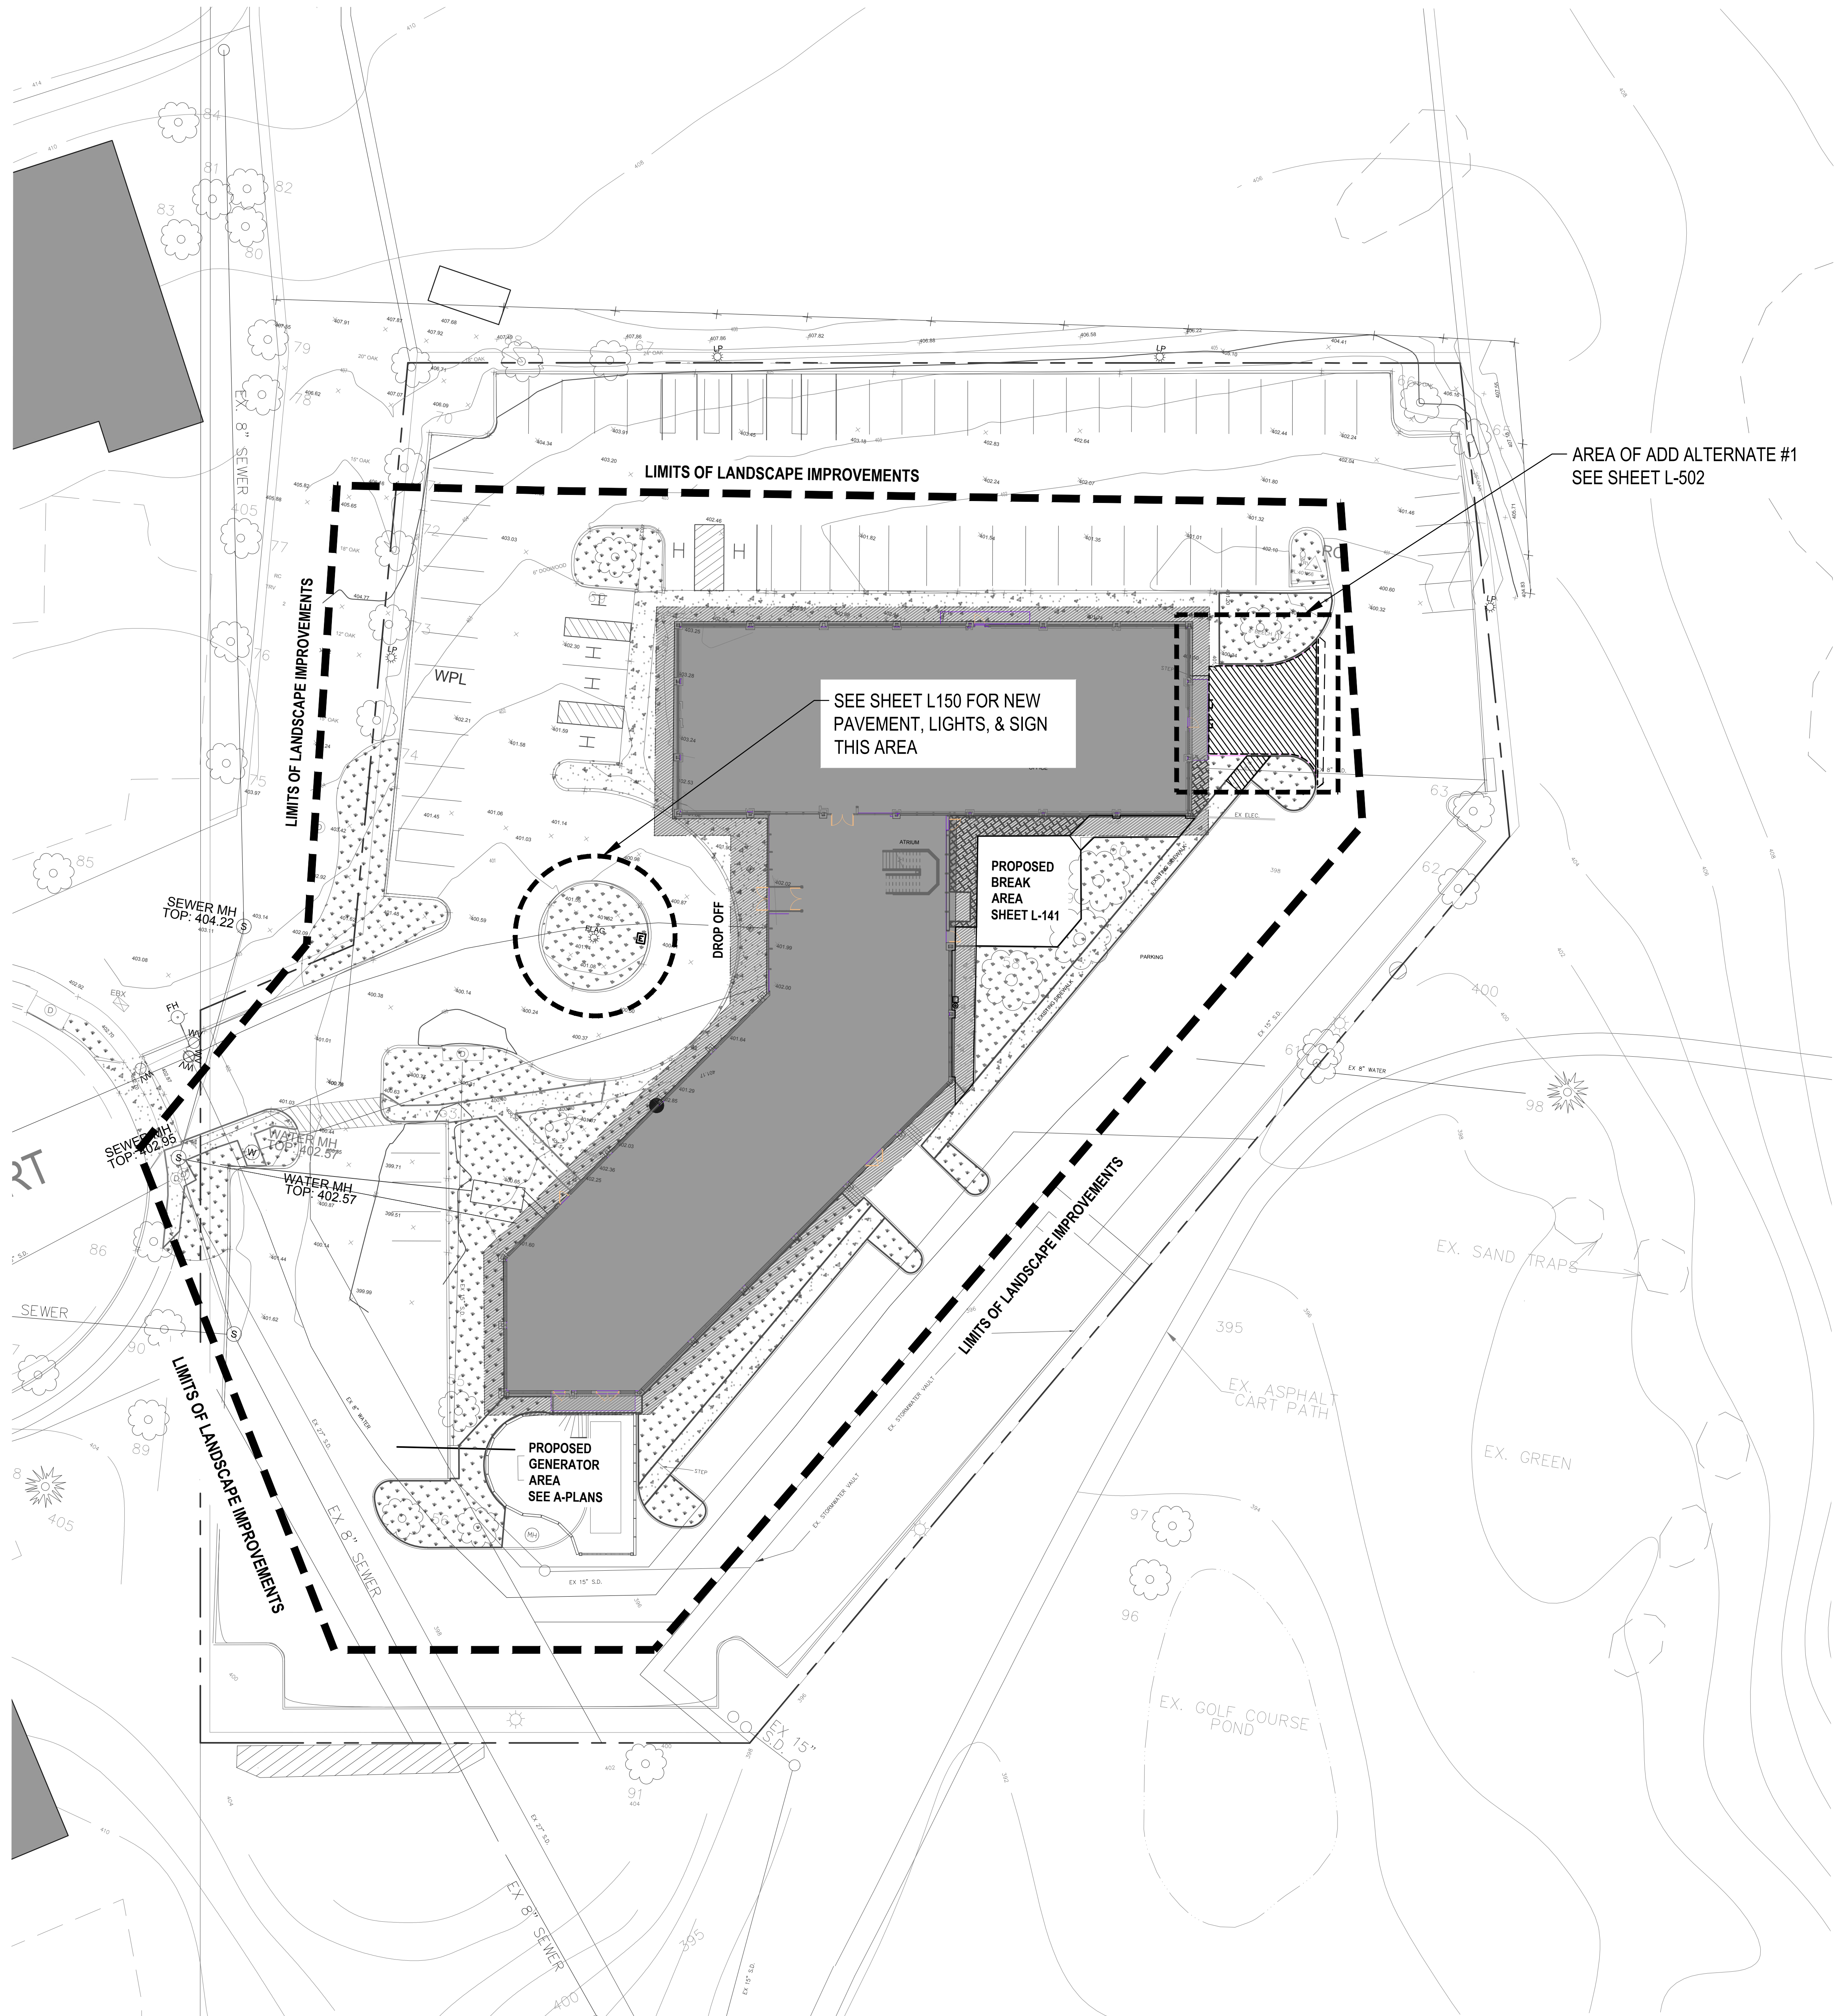
Table with 2 columns: Phase and Date. Includes entries like Phase: IFB SUBMISSION Date: 2022.02.18.

GENERAL NOTES & ABBREVIATIONS

Drawing No.

L-002





EXISTING LEGEND:	
UNDERGROUND STORM SEWER	BT
STORM SEWER MANHOLE	BT
STORM SEWER CATCH BASIN	CB CB
UNDERGROUND SANITARY SEWER	SA
SANITARY SEWER MANHOLE	SA
SANITARY SEWER CLEANOUT	SC
UNDERGROUND WATER	W
FIRE HYDRANT	W
WATER MANHOLE	W
WATER VALVE	W
UNDERGROUND ELECTRIC	DH
OVERHEAD ELECTRIC	U/E
UTILITY POLE	U
LIGHT POLE	U
ELECTRIC MANHOLE	U
GUY WIRE	U
UNDERGROUND TELEPHONE	TEL
TELEPHONE MANHOLE	T
UNDERGROUND NATURAL GAS	G
GAS LINE VALVE	G
CONCRETE AND GRANITE CURB	C
PIPE BOLLARD	B
CHAIN LINK FENCE	X
WOOD FENCE	W
GUIDE RAIL	G
SINGLE POST SIGN	S
DOUBLE POST SIGN	S
MAJOR CONTOUR	95
MINOR CONTOUR	94
SPOT ELEVATION	94.55
BENCHMARK	B
BASELINE POINT	B
PROPERTY MONUMENT	M
PROPERTY LINE	P
EDGE OF WATER	E
BORING LOCATION	B
HEDGE ROW AND BRUSH LINE	H
SHRUB	S
DECIDUOUS TREE	D
CONIFEROUS TREES	C



APPROVED BY CITY OF ROCKVILLE, MD

DIRECTOR OF PUBLIC WORKS DATE
SEPARATE BUILDING PERMITS FROM INSPECTION SERVICES DIVISION ARE REQUIRED FOR ON-SITE CONSTRUCTION

Key Plan

SCALE: 1" = 33'-0"

No.	Revision	Date

Project Name
**CITY OF ROCKVILLE
6 TAFT COURT RENOVATION**

ROCKVILLE MARYLAND

DELTA
ENGINEERS, ARCHITECTS, & SURVEYORS

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Seal of the State of Maryland
Professional Engineer
No. 1385
Date: 2022.02.18


Phase
IFB SUBMISSION
Project No.
2019.331.004

Drawing Title
**EXISTING CONDITIONS
PLAN**

Drawing No.
L-120

- GENERAL EXISTING CONDITIONS NOTES**
- EXISTING CONDITIONS PLAN BASED ON SURVEY DATA PROVIDED BY KIM ENGINEERING, INC. 19634 CLUB HOUSE ROAD, SUITE 310 GAITHERSBURG, MARYLAND 20886 (301-337-6734).
 - TOPOGRAPHIC AND ELEVATION DATA COLLECTED BY DELTA ENGINEERS, ARCHITECTS, LAND SURVEYORS, & LANDSCAPE ARCHITECTS DPC AND FIELD NOTES AND MEASUREMENTS BY LANDSCAPE ARCHITECT ON 01.10.2022.
 - UNDERGROUND UTILITY LOCATIONS ARE NOT GUARANTEED, NOR IS THERE ANY GUARANTEE THAT ALL EXISTING UTILITIES WHETHER FUNCTIONAL OR ABANDONED WITHIN THE PROJECT AREA ARE SHOWN ON THIS DRAWING. THE CONTRACTOR SHALL DETERMINE THE EXACT LOCATION OF ALL UNDERGROUND UTILITIES BEFORE STARTING WORK AND SHALL BE RESPONSIBLE FOR ALL DAMAGE RESULTING FROM HIS WORK. CONTRACTOR SHALL NOTIFY MISS UTILITY, CALL "MISS UTILITY" AT 1-800-257-7777, 48 HOURS PRIOR TO THE START OF WORK. THE EXCAVATOR MUST NOTIFY ALL PUBLIC UTILITY COMPANIES WITH UNDER GROUND FACILITIES IN THE AREA OF PROPOSED EXCAVATION AND HAVE THOSE FACILITIES LOCATED BY THE UTILITY COMPANIES PRIOR TO COMMENCING EXCAVATION.
 - CONTRACTOR TO VERIFY ALL CONDITIONS IN THE FIELD AND REPORT ANY DISCREPANCIES TO THE LANDSCAPE ARCHITECT IMMEDIATELY.



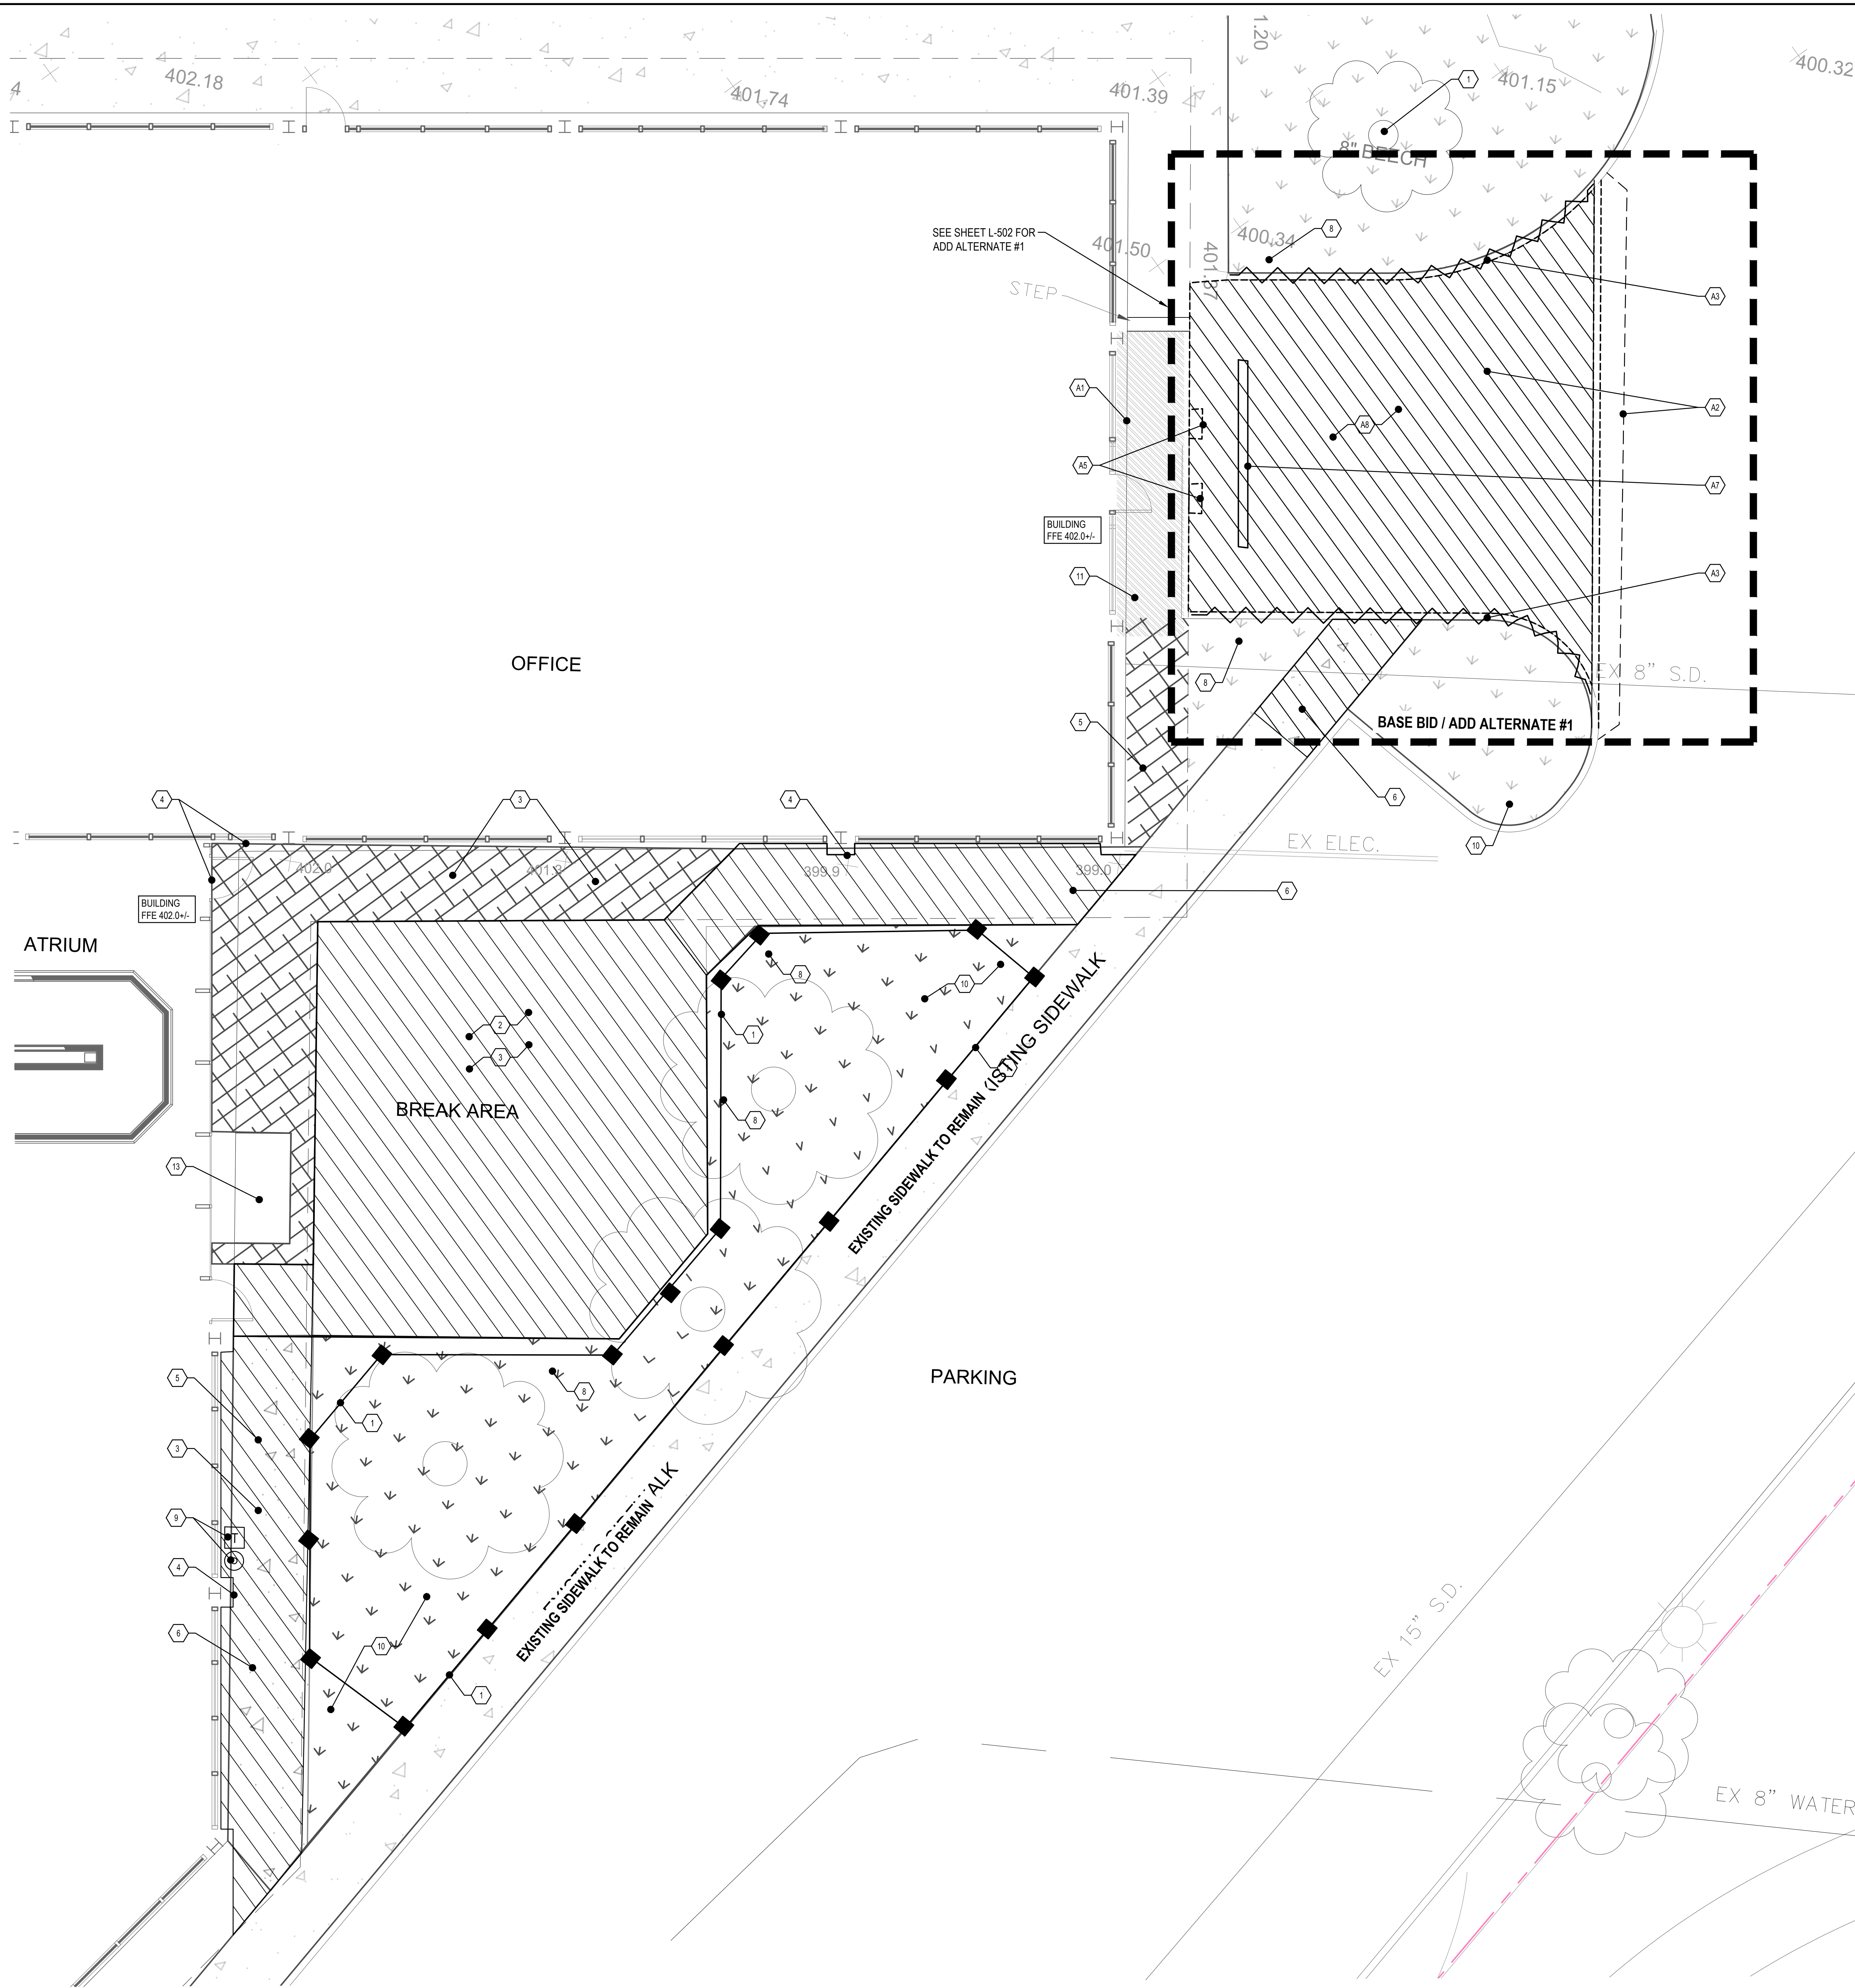

DEMOLITION KEY NOTES - BASE BID

- 1 PROTECT EXISTING TREES WITH FENCE, DO NOT COMPACT, STOCKPILE, OR IMPACT ROOTS. SEE DETAIL 3A-501.
- 2 REMOVE PAVER PATIO, DISPOSE OF PAVERS AND CONCRETE.
- 3 EXCAVATE AND PREPARE FOR NEW PAVER BASE, SEE GRADING AND DETAILS FOR DEPTHS.
- 4 PROTECT BUILDING THRESHOLD, FACADE, BRICK, AND WINDOWS.
- 5 REMOVE MULCH & SOIL TO PREPARE FOR NEW CONCRETE WALK.
- 6 REMOVE CONCRETE WALK, DISPOSE OFF SITE.
- 7 REMOVE 2 BUMPERS ON DOCK FACE & RETURN TO OWNER.
- 8 REMOVE ASSORTED SMALL SHRUBS & ROOTS.
- 9 SALVAGE ASH URN & TRASH BIN, RETURN TO OWNER.
- 10 SPRAY SOD WITH OWNER APPROVED HERBICIDE, RAKE DEAD TURF FROM SURFACE. DO NOT REMOVE SOIL MECHANICALLY EXCEPT FOR 6-8" BEHIND SIDEWALK EDGE.
- 11 POWERWASH CONCRETE PAVEMENT SURFACE OF DOCK.
- 12 SEE STANDARD DEMOLITION & REMOVAL NOTES, SHEET L-902.
- 13 SEE ARCHITECTURAL DRAWINGS FOR VENTILATION PLANS / REMOVAL, COORDINATE WITH ARCHITECT.

DEMOLITION KEY NOTES - ADD ALTERNATE #1

- A1 PROTECT BUILDING THRESHOLD, FACADE, BRICK AND WINDOWS.
- A2 SAWCUT & REMOVE CONCRETE & ASPHALT PAVEMENTS, DISPOSE OFF SITE.
- A3 REMOVE CONCRETE CURBS TO JOINT.
- A4 REMOVE CONCRETE WALK TO NEAREST JOINT, DISPOSE OFF SITE.
- A5 REMOVE 2 BUMPERS ON DOCK FACE & RETURN TO OWNER.
- A6 POWERWASH CONCRETE PAVEMENT SURFACE OF DOCK.
- A7 ABANDON TRENCH DRAIN, PLUG OUTLETS & FILL WITH CRUSHED STONE.
- A8 FILL AREA WITH MODIFIED FILL TO WITHIN 4" OF FINISHED GRADE. SO GRADES SLOPE A MIN. OF 3% AWAY FROM LOADING DOCK. INSTALL MIN. 4" TOPSOIL, SEED, FERTILIZE AND MULCH. SEE DETAILS 1-101-502.

DEMOLITION LEGEND:

UTILITY DEMOLITION	-X-X-X-X-
PAVEMENT DEMOLITION	Diagonal hatching
CURB DEMOLITION	Wavy hatching
TREE DEMOLITION	X
TREE PROTECTION FENCE	Box with X
OTHER DEMOLITION	Dashed line



APPROVED BY CITY OF ROCKVILLE, MD

DIRECTOR OF PUBLIC WORKS DATE
SEPARATE BUILDING PERMITS FROM INSPECTION
SERVICES DIVISION ARE REQUIRED FOR ON-SITE
CONSTRUCTION

Key Plan

SCALE: X" = XX' X"

No.	Revision	Date

Project Name
**CITY OF ROCKVILLE
6 TAFT COURT RENOVATION**

ROCKVILLE MARYLAND

DELTA
ENGINEERS, ARCHITECTS, & SURVEYORS


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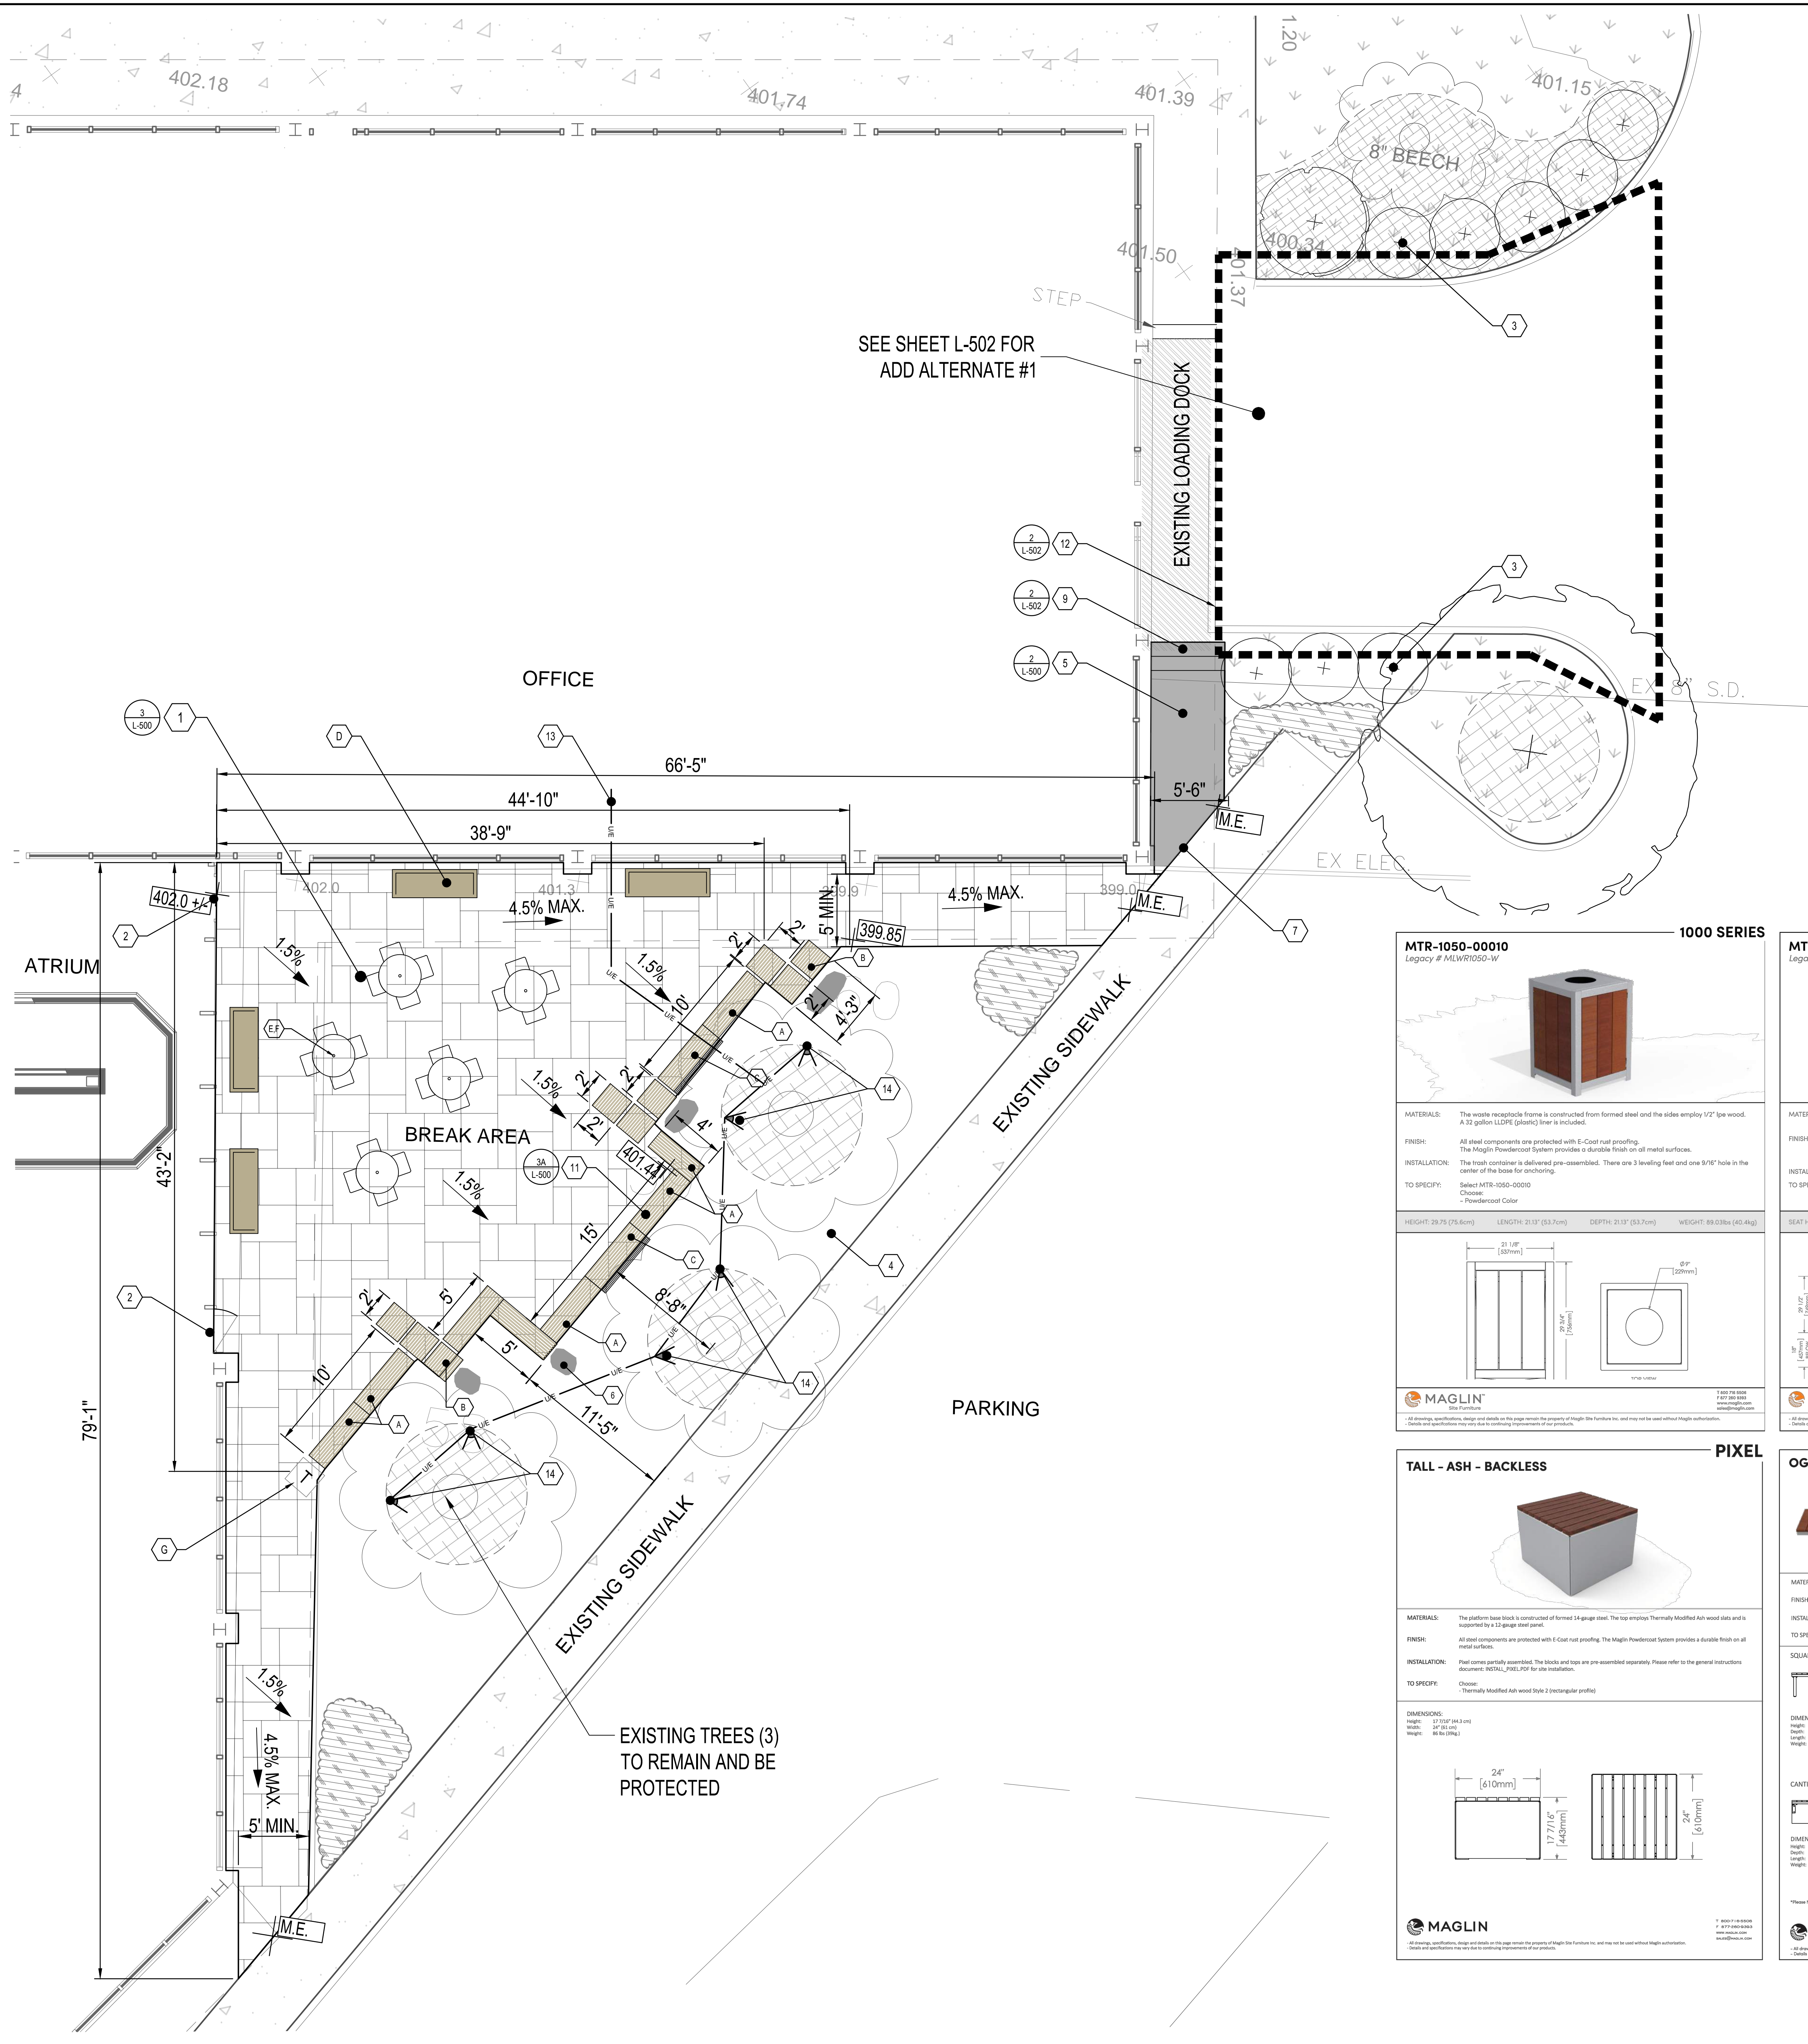
Seal of the State of Maryland
Professional Engineer
No. 144270
Date: 02/18/2022

Phase
IFB SUBMISSION
Project No.
2019.331.004
Date
2022.02.18

Drawing Title
**DEMOLITION PLAN
BREAK AREA AND
LOADING DOCK**

Drawing No.
L-140



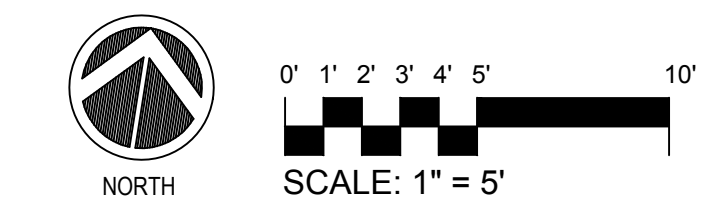

SITE PLAN LEGEND:	
BLUESTONE PATIO	[Symbol]
CONCRETE PAVEMENT	[Symbol]
UNDERGROUND ELECTRIC	U/E
BLUESTONE QUARRY BOULDER	[Symbol]
BENCH (BACKLESS)	[Symbol]
BENCH (WITH BACK)	[Symbol]
TABLE & CHAIRS	[Symbol]
DRAINAGE SLOPE ARROW	[Symbol]
TRASH RECEPTACLE	[Symbol]
SPOT ELEVATION	401.44

LAYOUT KEY NOTES	
1	BLUESTONE PAVER PATIO, SEE DETAIL 3A-500
2	MATCH ELEVATION AT BUILDING ENTRANCE(S), SET BLUESTONE PAVEMENT MAX 1/4" BELOW THRESHOLD
3	SEE SHEET L-150 FOR PLANTING PLAN
4	MAINTAIN TREE PROTECTION FENCE THROUGH CONSTRUCTION
5	NEW CONCRETE WALK
6	BLUESTONE QUARRY BOULDER, TYP.
7	EXPANSION JOINT, SEE DETAIL 2L-500
8	RESTORE LAWN WITH TOPSOIL, SEED, AND MULCH WITH STRAW, MATCH EDGE OF PAVEMENT
9	NEW PRECAST CONCRETE STEPS (3), 5' LENGTH, STONE TEXTURE, COLOR GRAY SEE DETAIL 2L-502
10	SEE SHEET L-502 FOR LOADING DOCK ADD ALTERNATE #1
11	BLUESTONE PAVER PATIO DETAIL AT BENCH LOCATIONS, SEE DETAIL 3A-L-500
12	HANDRAIL, SEE DETAIL
13	CONDUIT SLEEVE FOR ELECTRIC SERVICE TO ACCENT LIGHTS, SEE ARCHITECTURAL UTILITY DRAWINGS FOR SERVICE
14	INSTALL ACCENT LIGHTS PER MANUFACTURER SPECIFICATIONS, SEE SITE LIGHTING SCHEDULE

SITE AMENITY SCHEDULE			
SYMBL	QTY	ITEM	DETAIL NO./SHEET
A	(7) 5' L (1) 4' L	MODULAR BENCH (BACKLESS); BENCH MODEL "OGDEN" LENGTHS 3' 4" 5' 6' MANUFACTURER: MAGLIN SITE FURNITURE, SQUARE LEG OPTION, METAL COLOR: BRONZE 14, WOOD MATERIAL: THERMALLY MODIFIED ASH.	SEE MANUFACTURE INFORMATION
B	(3) (3) (3)	SQUARE MODULAR BENCH "PIXEL" MANUFACTURER: MAGLIN SITE FURNITURE, METAL COLOR: BRONZE 14, WOOD MATERIAL: THERMALLY MODIFIED ASH. SIZE: TALL (SIZE: SHORT X 2 (STACKED) SIZE: SHORT X 3 (STACKED))	3A-L-500 & SEE MANUFACTURE INFORMATION
C	(2) 5' L	MODULAR BENCH (WITH BACK); MODEL "OGDEN" LENGTHS 3' 4" 5' 6' MANUFACTURER: MAGLIN SITE FURNITURE, SQUARE LEG OPTION, METAL COLOR: BRONZE 14, WOOD MATERIAL: THERMALLY MODIFIED ASH.	SEE MANUFACTURE INFORMATION
D	4	STANDARD BENCH: BACKED BENCH MODEL "450" MANUFACTURER: MAGLIN SITE FURNITURE, COLOR: BRONZE 14	SEE MANUFACTURE INFORMATION
E	5	TABLES W/ BUILT IN CHAIRS: MODEL "400 SERIES, CLUSTER SEATING" MANUFACTURER: MAGLIN SITE FURNITURE, COLOR: BRONZE 14 (2 SETS TO BE ADA COMPLIANT)	SEE MANUFACTURE INFORMATION
G	1	TRASH RECEPTACLE: MODEL "1000 SERIES" 1100" TRASH CONTAINER, MANUFACTURER: MAGLIN SITE FURNITURE, COLOR: BRONZE 14, WOOD MATERIAL: THERMALLY MODIFIED ASH	SEE MANUFACTURE INFORMATION

SITE LIGHTING SCHEDULE								
SYM.	QTY	DESC.	MANUFACTURER	MODEL	PART NO.	WATTS	VOLTS	REMARKS / SPACING
2	2	ENTRANCE SIGN LIGHT	LITPARA	QTE LED PS		86		YORK MOUNT
6	6	ACCENT LIGHT #1	SEDERA	LIGHTING	JAMAICA		12V	FINISH BRONZE
		LIGHTING 12V CABLE						COORDINATE WITH ELECTRICAL/LANDSCAPE CONTRACTOR



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Key Plan

SCALE: X" = XX'-X"

No.	Revision	Date

Project Name
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6 TAFT COURT RENOVATION**

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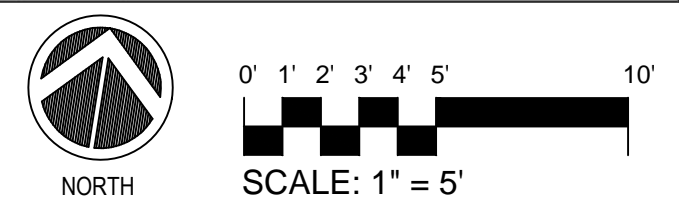
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Seal of the City of Rockville, Maryland, dated 2022.02.18.

Phase: IFB SUBMISSION
Project No.: 2019.331.004
Date: 2022.02.18

Drawing Title
**LAYOUT & GRADING PLAN
BREAK AREA & LOADING DOCK**

Drawing No.



L-141

MTR-1050-00010
Legacy # MLW1050-W

1000 SERIES

MATERIALS: The waste receptacle frame is constructed from formed steel and the sides employ 1/2" pine wood. A 32 gallon LLDPE (plastic) liner is included.

FINISH: All steel components are protected with E-Coat rust proofing. The Maglin Powdercoat System provides a durable finish on all metal surfaces.

INSTALLATION: The trash container is delivered pre-assembled. There are 3 leveling feet and one 9/16" hole in the center of the base for anchoring.

TO SPECIFY: Select MTR-1050-00010
Choose: Powdercoat Color

HEIGHT: 36.75" (933mm) LENGTH: 21.12" (537mm) DEPTH: 21.12" (537mm) WEIGHT: 89.23lbs (40.4kg)

MAGLIN SITE FURNITURE

MTB-0400-00009
Legacy # MLT0400-09-W-CA

400 SERIES

MATERIALS: The frame is H.S. steel tube and flat bar. Table top and seats are manufactured using pine wood slats.

FINISH: All steel components are protected with E-Coat rust proofing. The Maglin Powdercoat System provides a durable finish on all metal surfaces. Wood slats are treated with preservative sealers.

INSTALLATION: The table is delivered pre-assembled. Holes (3/8") are provided for securing to base.

TO SPECIFY: Select MTB-0400-00009
Choose: Powdercoat Color

SEAT HEIGHT: 17.75" (453mm) LENGTH: 62.75" (1604mm) TABLE LENGTH: 36" (914mm) WEIGHT: 276.91lbs (126.0kg)

MAGLIN SITE FURNITURE

BENCHES (6 FT)

BENCH INSTALLATION

- Anchoring hole layouts vary slightly by model type
- Place bench on foundation and mark for drilling to ensure proper installation.
- Unless otherwise noted, there are 4 - 1/2" mounting holes per bench. We suggest 3/8" concrete anchors.

Diagram 1

Diagram 1

Plowing Stones
Benches can be lagged to the paving stones directly. For a more secure installation, we suggest pouring a concrete footing between the pavers. To install furniture, drill through the pavers and into the concrete. Using long lag bolts, furniture can be bolted down through the pavers and lagged into the concrete footing. Concrete footing can also be poured to bring mounting surface up to the same level as the pavers.

MAGLIN SITE FURNITURE

TALL - ASH - BACKLESS

MATERIALS: The platform base block is constructed of formed 14 gauge steel. The top employs Thermally Modified Ash wood slats and is supported by a 12 gauge steel panel.

FINISH: All steel components are protected with E-Coat rust proofing. The Maglin Powdercoat System provides a durable finish on all metal surfaces.

INSTALLATION: Feet corner partially assembled. The slats and tops are pre-assembled separately. Please refer to the general instructions document (MTR-TALL_ASH_T50 for site installation).

TO SPECIFY: Choose: Thermally Modified Ash wood Slats (2 rectangular profiles)

DIMENSIONS:
Height: 17.75" (453mm)
Depth: 24" (610mm)
Width: 60" (1524mm)

MAGLIN SITE FURNITURE

OGM1900-SS5

OGDEN

MATERIALS: The seat pan is constructed from steel. The seat employs pine wood, HDPE (plastic), or HDPE (paper composite) slats. Thickness is 2" HDPE 1" HDPE 3/4"

FINISH: All steel components are protected with E-Coat rust proofing. The Maglin Powdercoat System provides a durable finish on all metal surfaces.

INSTALLATION: The seat and backrests come pre-assembled with boards. Mounting system comes as a separate component. Reference INSTALLATION INSTRUCTIONS (OGM1900) document for crate assembly and installation instructions.

TO SPECIFY: Please contact your Maglin Site Furniture Representative.

SQUARE LEG - MS1 **PEDestal LEG - MS2** **FRONT TO BACK SLATS (FB)**

FRONT TO BACK SLATS (FB)

LEFT TO RIGHT SLATS (LR)

CANTILEVER - MS3 **WALLMOUNT - MS4**

DIMENSIONS:
Height: 18.00" (457mm)
Depth: 18.00" (457mm)
Length: 36.00" (914mm)
Weight: Variable

DIMENSIONS:
Height: 18.00" (457mm)
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Length: 36.00" (914mm)
Weight: Variable

MAGLIN SITE FURNITURE

OGM1900-B1-SS5

OGDEN

MATERIALS: The seat pan is constructed from steel. The seat employs pine wood, HDPE (plastic), or HDPE (paper composite) slats. Thickness is 2" HDPE 1" HDPE 3/4"

FINISH: All steel components are protected with E-Coat rust proofing. The Maglin Powdercoat System provides a durable finish on all metal surfaces.

INSTALLATION: The seat and backrests come pre-assembled with boards. Mounting system comes as a separate component. Reference INSTALLATION INSTRUCTIONS (OGM1900) document for crate assembly and installation instructions.

TO SPECIFY: Please contact your Maglin Site Furniture Representative.

SQUARE LEG - MS1 **PEDestal LEG - MS2** **FRONT TO BACK SLATS (FB)**

FRONT TO BACK SLATS (FB)

LEFT TO RIGHT SLATS (LR)

CANTILEVER - MS3 **WALLMOUNT - MS4**


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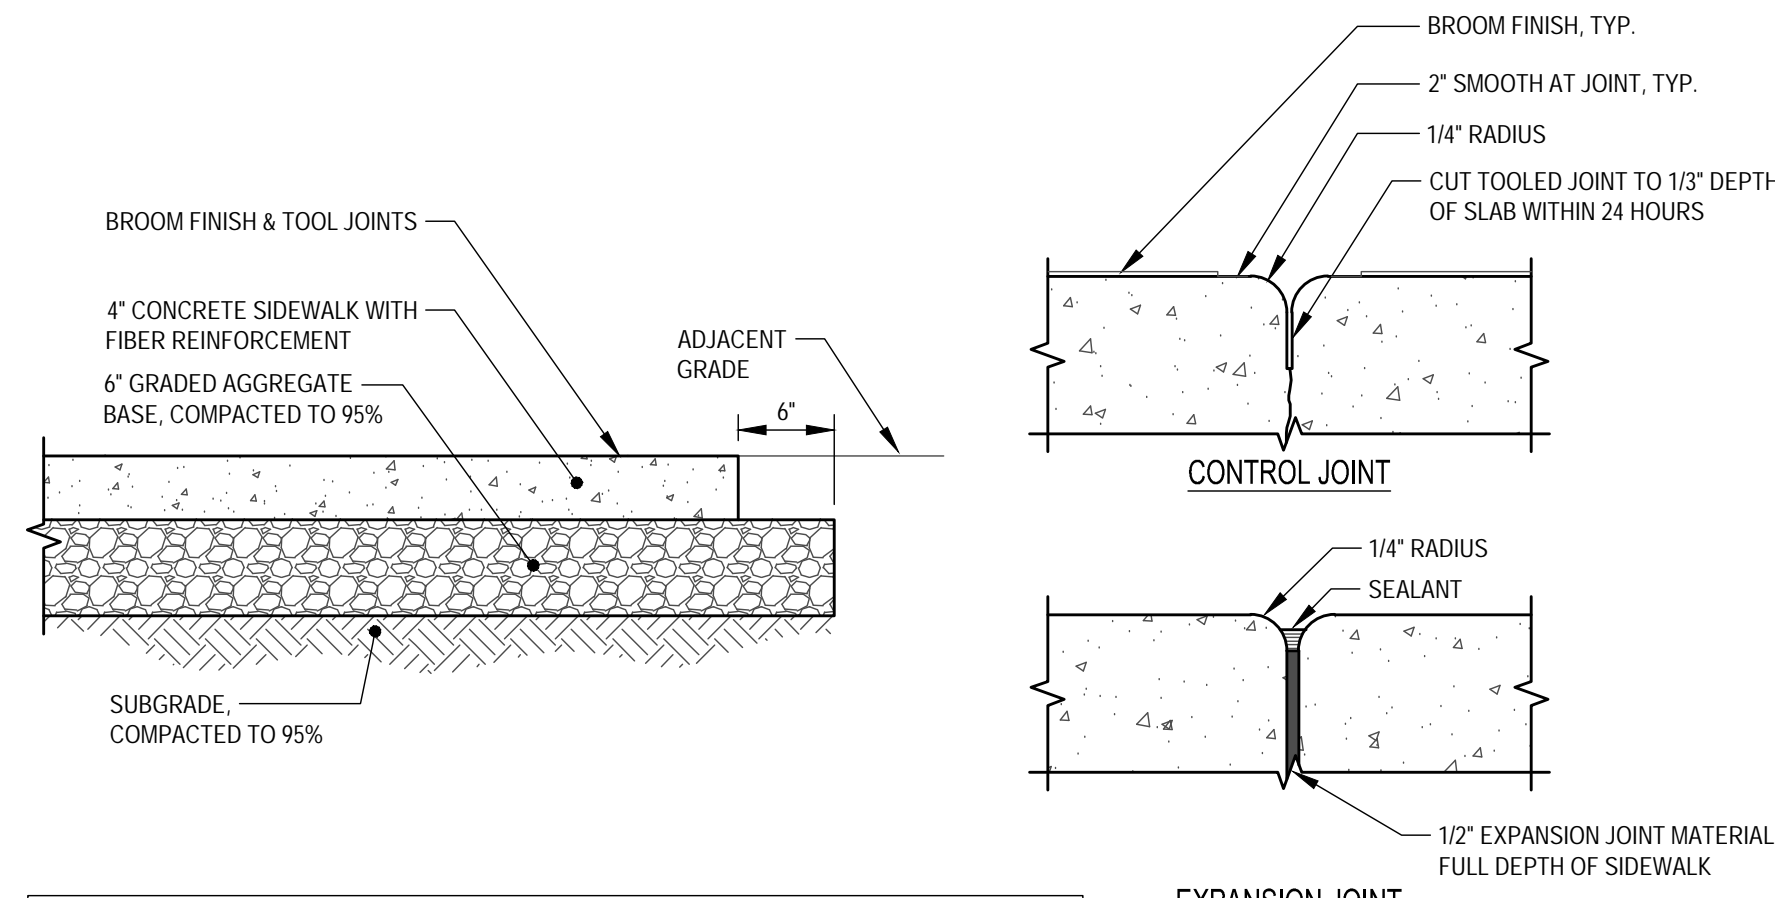
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MAGLIN SITE FURNITURE




CONSTRUCTION SPECIFICATIONS:
 1. FOLLOW STATE PAVEMENT SPECIFICATIONS.

1 STANDARD DUTY ASPHALT PAVEMENT PATCH
 L-500 SCALE: NONE

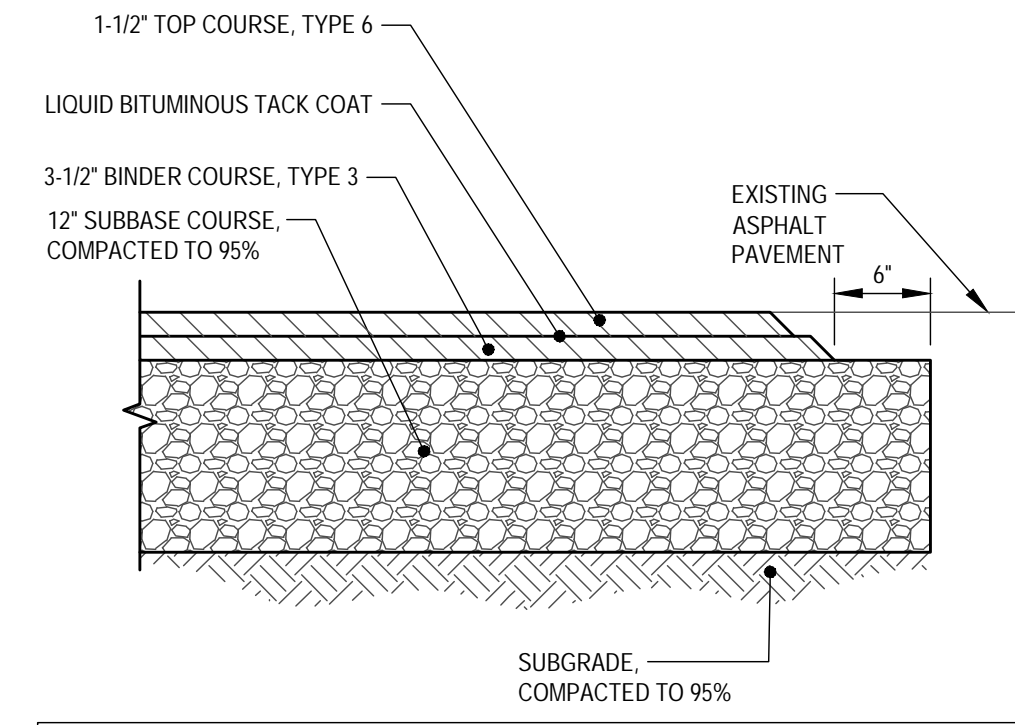


CONSTRUCTION SPECIFICATIONS:
 1. CONCRETE SURFACE TO BE BROOM FINISH WITH PICTURE FRAME PATTERN, 5'X5' SPACING.
 2. MAXIMUM CROSS SLOPE 1.5%


**2 4\"/>
 L-500 SCALE: NONE**

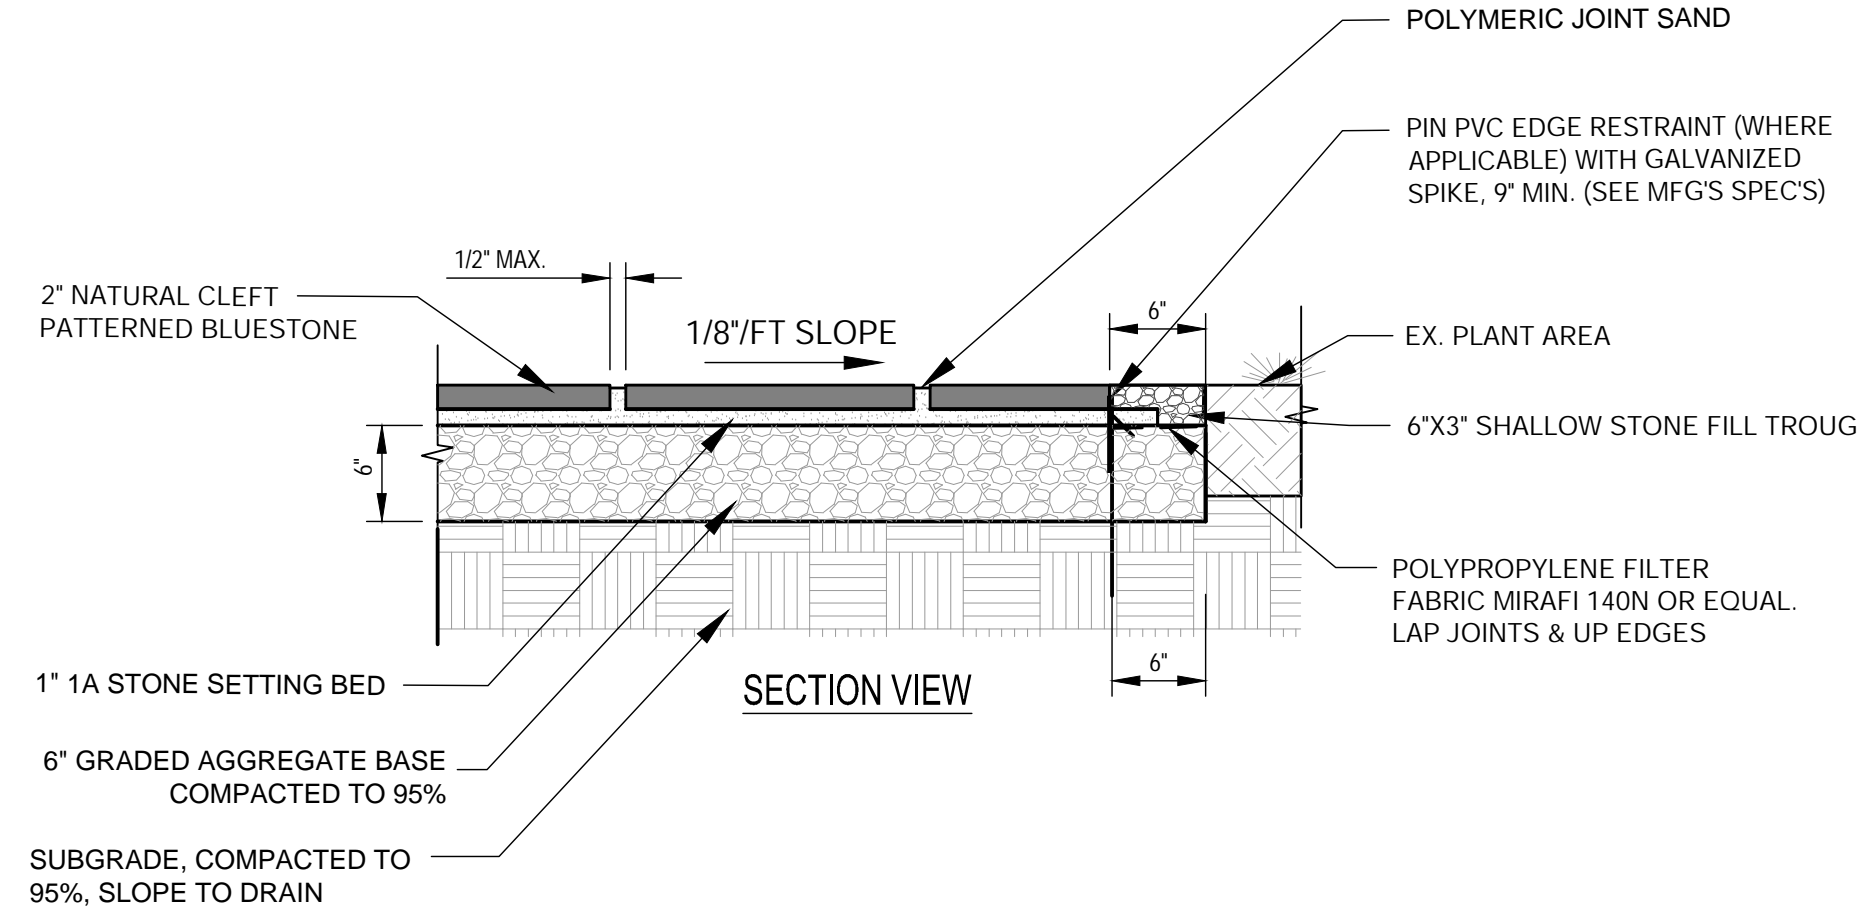


3 BLUESTONE PAVER PATIO DETAIL
 L-500 SCALE: NONE

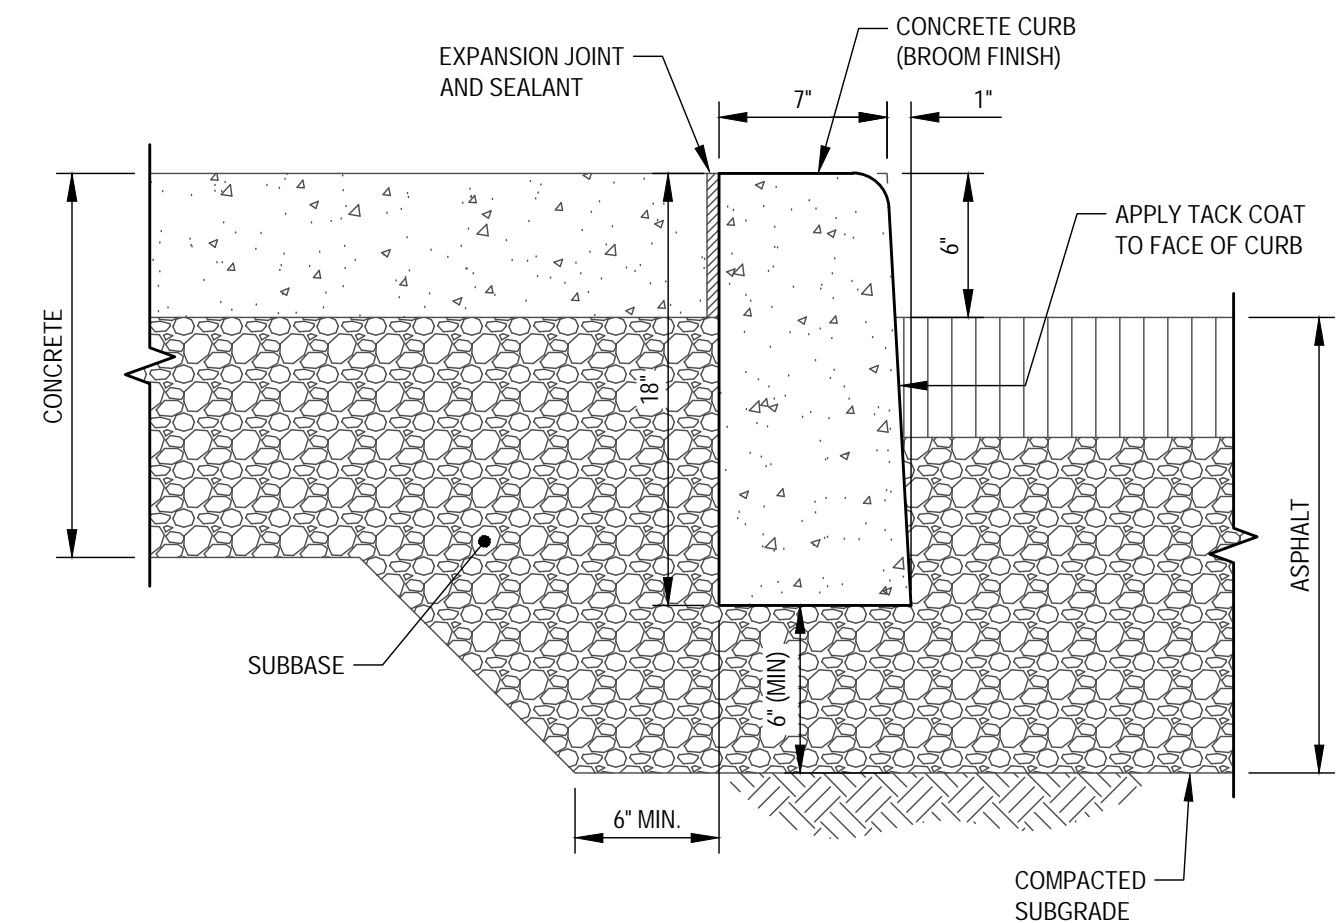


4 CONCRETE CURB DETAIL
 L-500 SCALE: NONE

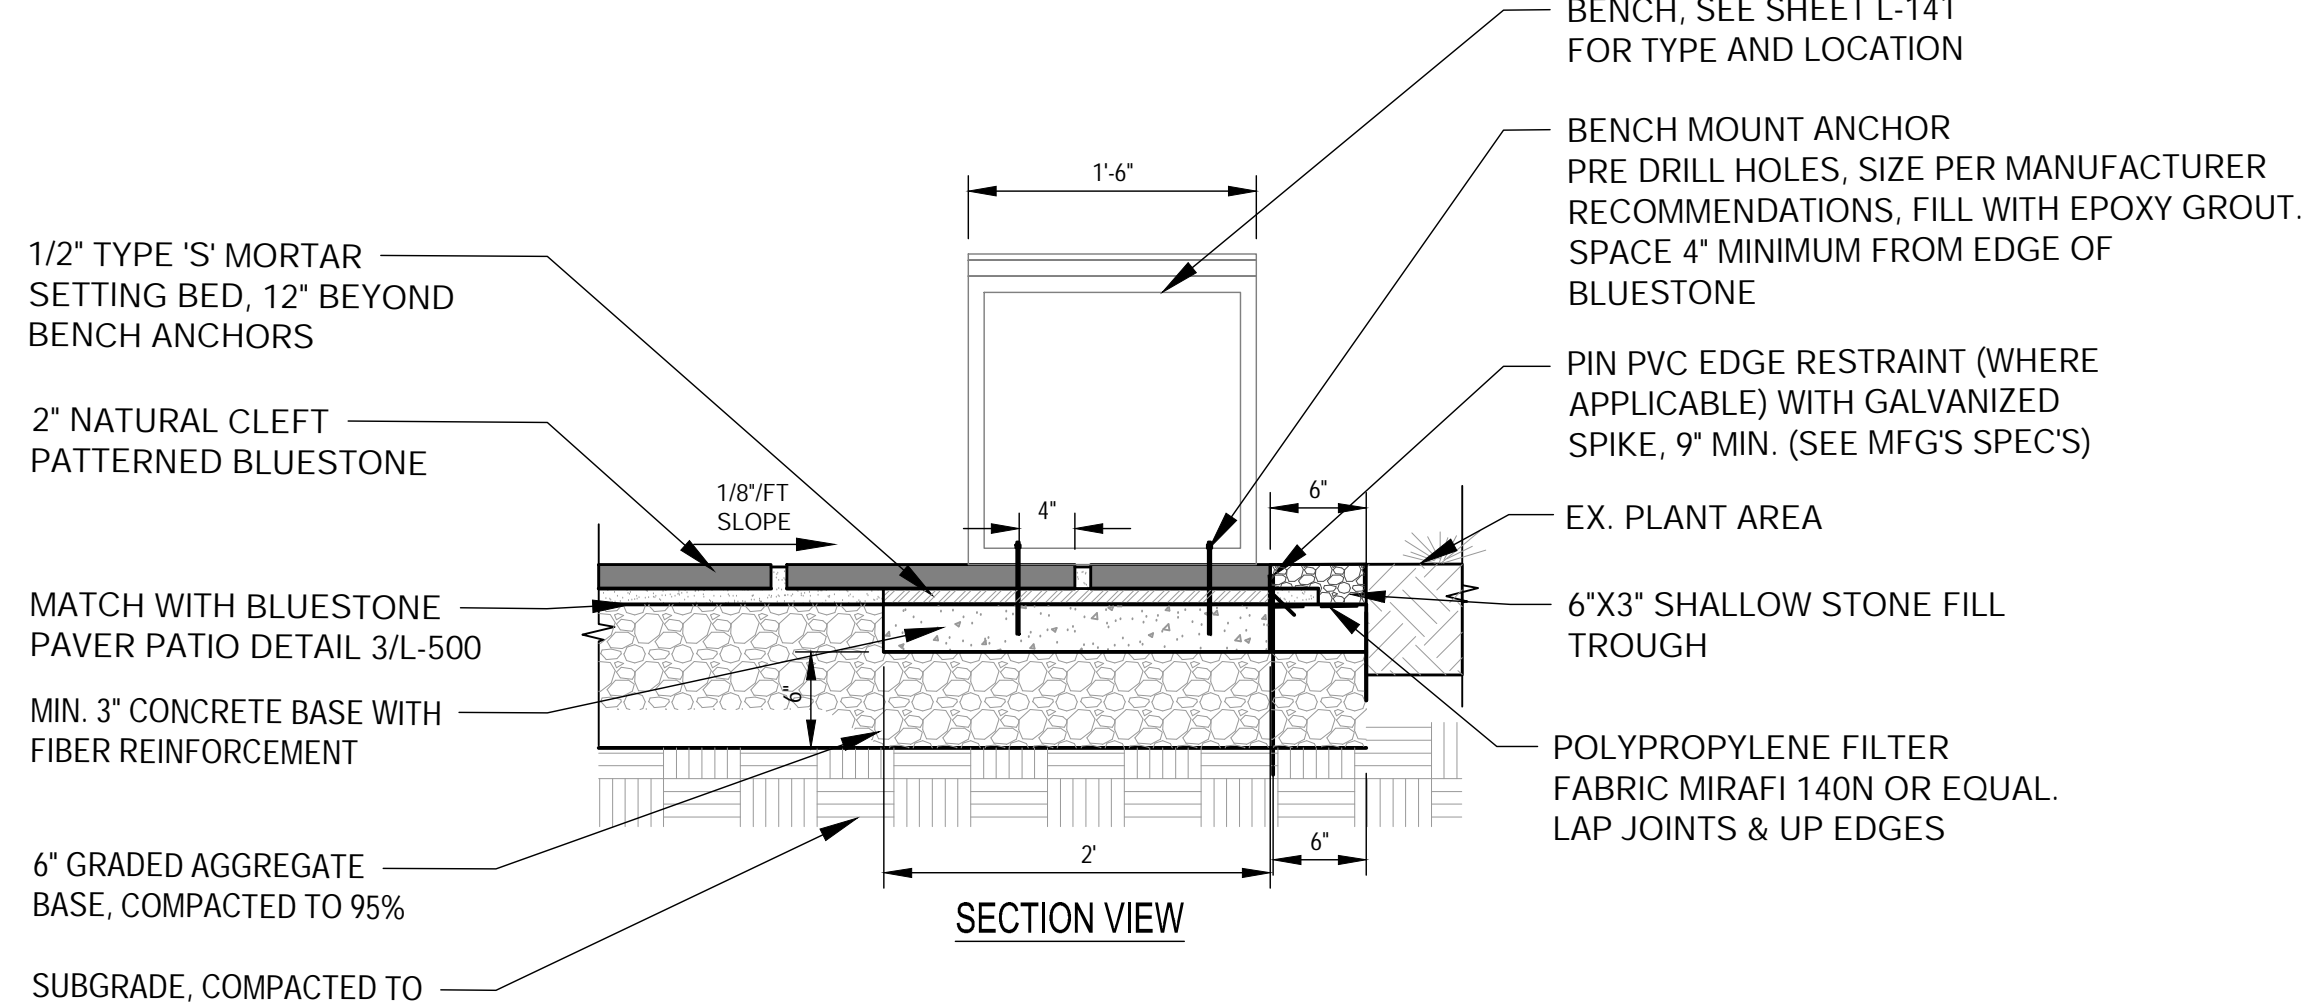


3A BLUESTONE PAVER PATIO DETAIL AT BENCH LOCATIONS
 L-500 SCALE: NONE

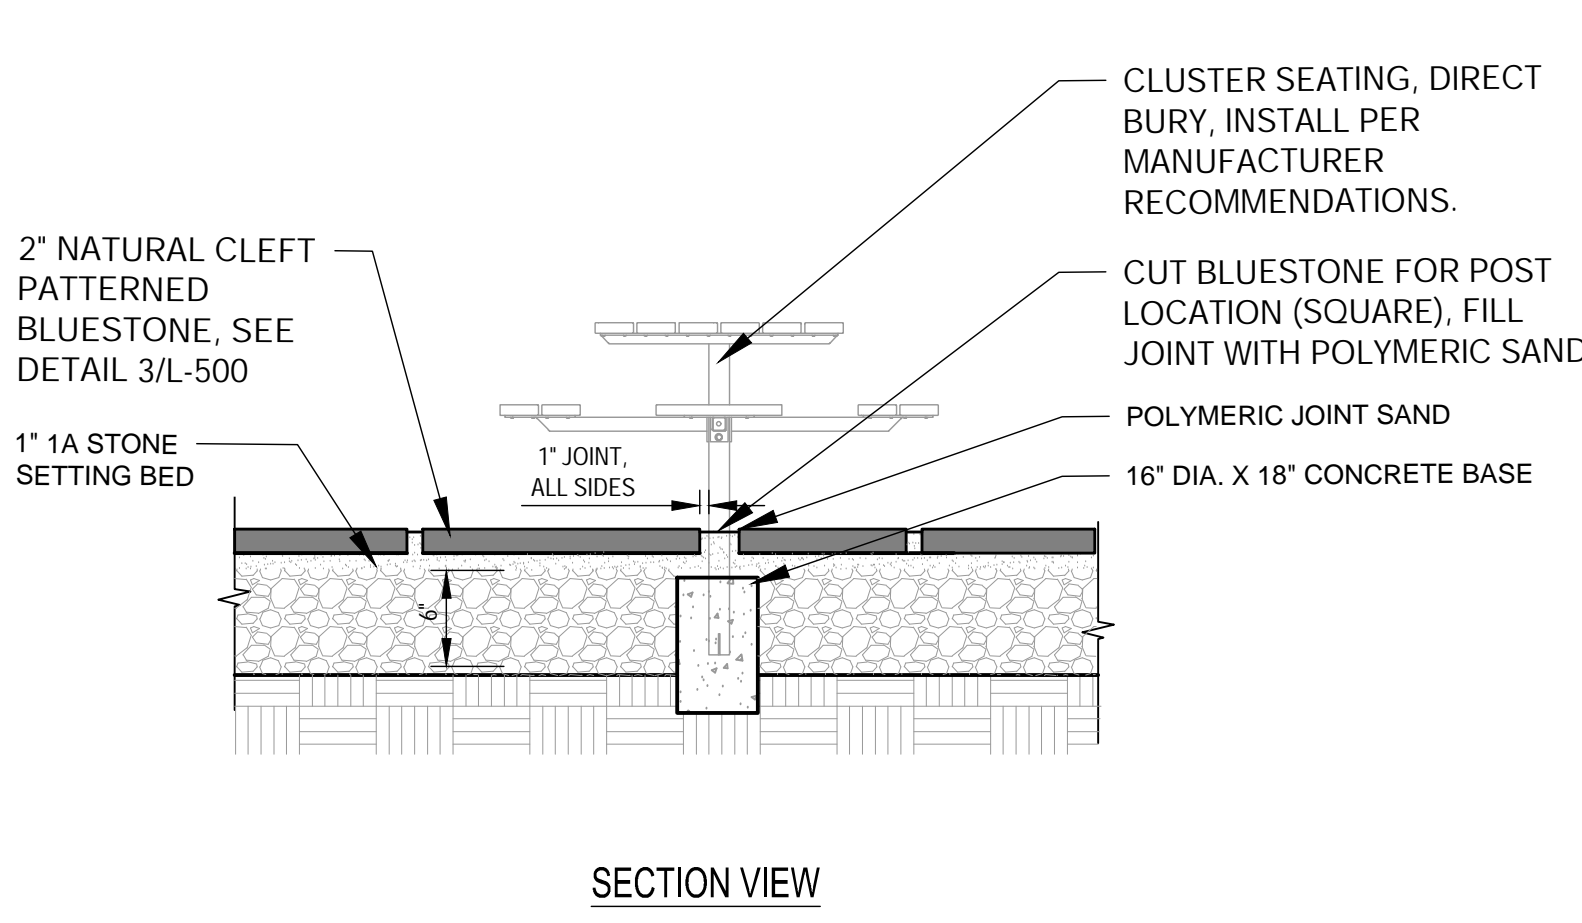

3B BLUESTONE PAVER PATIO DETAIL AT BENCH LOCATIONS
 L-500 SCALE: NONE

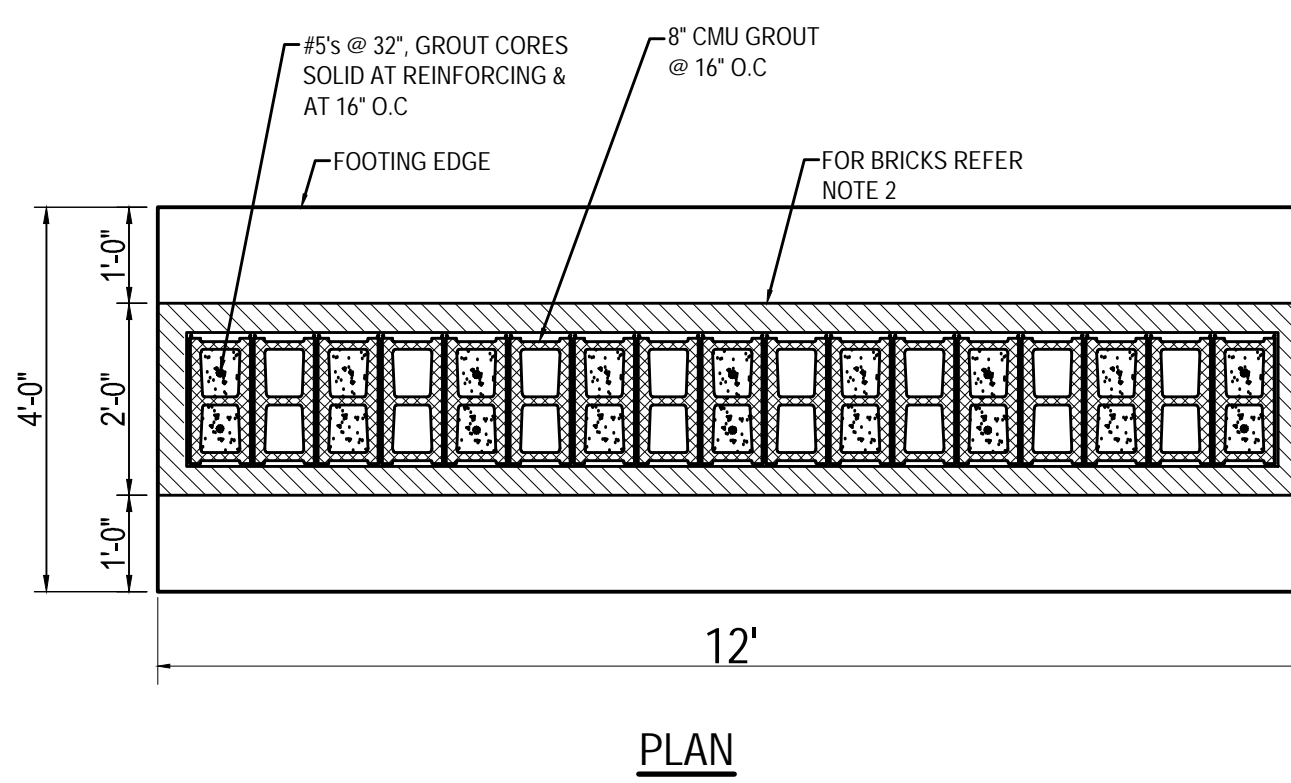


RENDERING

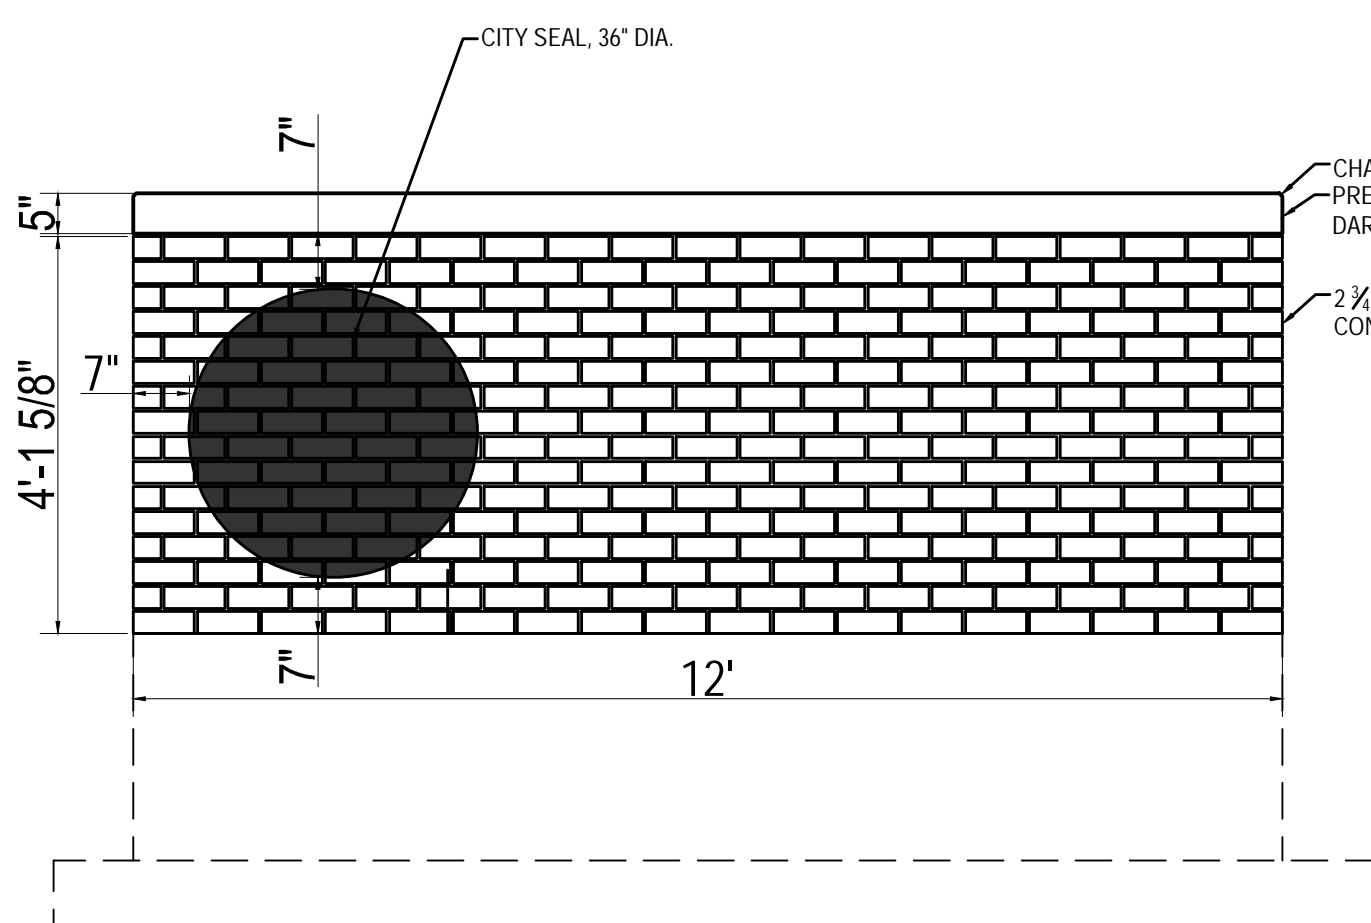

CONSTRUCTION SPECIFICATIONS:
 1. CONTRACTOR TO COORDINATE WITH CITY OF ROCKVILLE TO DETERMINE DESIRED LOGO, TEXT STYLE, TEXT SIZE, AND COLORS. SUBMIT SHOP DRAWING FOR REVIEW AND APPROVAL.
 2. SIGN LOGO TO BE PAINTED 3/8\"/>

5 ENTRANCE SIGN DETAIL
 L-500 SCALE: NONE

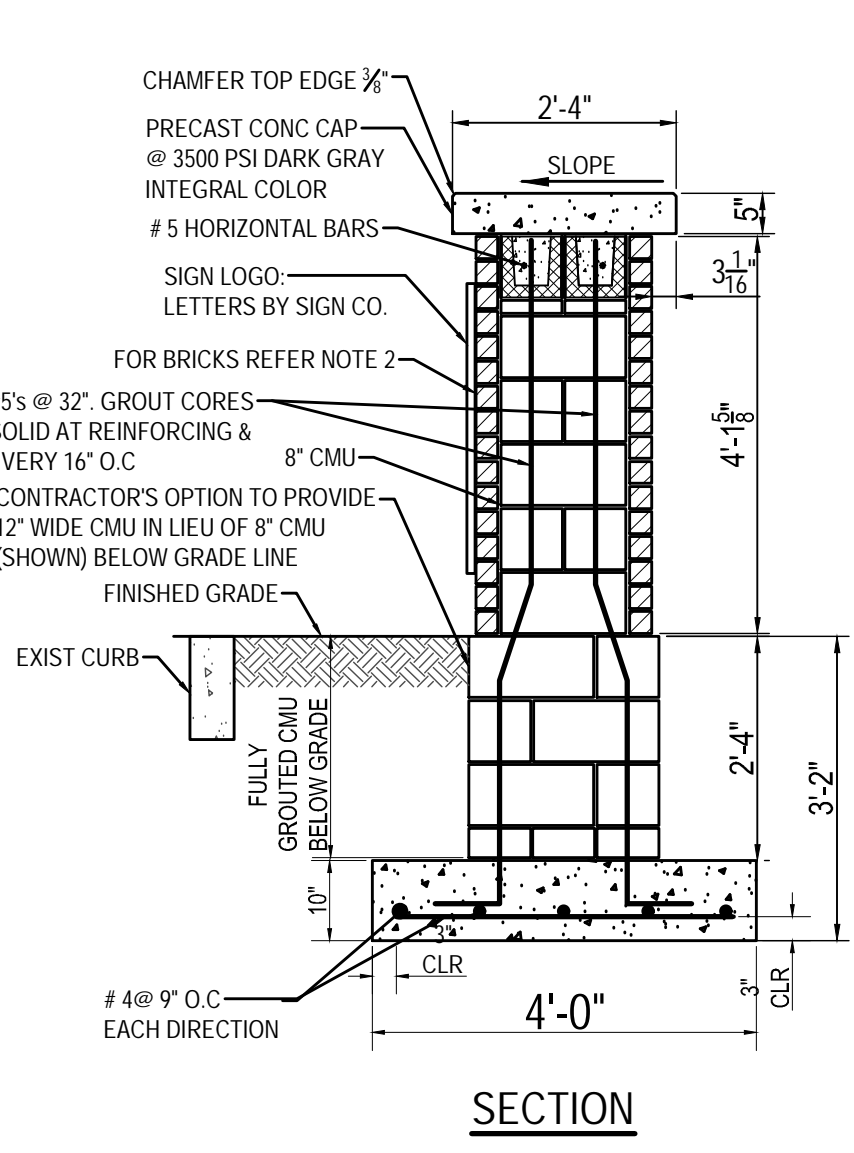

MAT DETAILS
 SEE PLACEMENT GUIDELINES BELOW

DOME SPACING
 1.6\"/>

DOME SECTION
 0.9\"/>

PLACEMENT GUIDELINES

NOTES
 1. THE DETECTABLE WARNING SURFACE SHALL BE LOCATED SO THAT THE EDGE NEAREST THE CURB LINE IS 6 TO 8 INCHES FROM THE FACE OF CURB.
 2. FOR SKIRMED APPLICATIONS DETECTABLE WARNING SHALL BE PLACED SUCH THAT THE DOMES CLOSEST TO THE BACK OF CURB ARE NO LESS THAN 0.5\"/>

APPROVED
 DIRECTOR - OFFICE OF TRAVEL DEVELOPMENT
 APPROVAL - BSA
 REVISION
 APPROVAL - FEDERAL HIGHWAY ADMINISTRATION
 APPROVAL - 2-18-04
 REVISION
 APPROVAL - 3-31-04
 REVISION
 APPROVAL - 4-17-06
 REVISION
 APPROVAL - 4-3-08
 REVISION

Maryland Department of Transportation STATE HIGHWAY ADMINISTRATION STANDARDS FOR HIGHWAYS AND INCIDENTAL STRUCTURES

DETECTABLE WARNING SURFACES
 STANDARD NO. MD 655.40

6 DETECTABLE WARNING SURFACES DETAIL
 L-500 SCALE: NONE



APPROVED BY CITY OF ROCKVILLE, MD
 DIRECTOR OF PUBLIC WORKS DATE
 SEPARATE BUILDING PERMITS FROM INSPECTION SERVICES DIVISION ARE REQUIRED FOR ON-SITE CONSTRUCTION

Key Plan

No.	Revision	Date

Project Name
CITY OF ROCKVILLE
6 TAFT COURT RENOVATION

ROCKVILLE MARYLAND

DELTA
 ENGINEERS, ARCHITECTS, & SURVEYORS
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 Fax: 301.718.9520
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 www.delta-eas.com

Seal

 Phase
 IFB SUBMISSION
 Project No.
 2019.331.004
 Date
 2022.02.18


Drawing Title
SITE DETAILS

Drawing No.
L-500



APPROVED BY CITY OF ROCKVILLE, MD


DIRECTOR OF PUBLIC WORKS DATE
SEPARATE BUILDING PERMITS FROM INSPECTION
SERVICES DIVISION ARE REQUIRED FOR ON-SITE
CONSTRUCTION

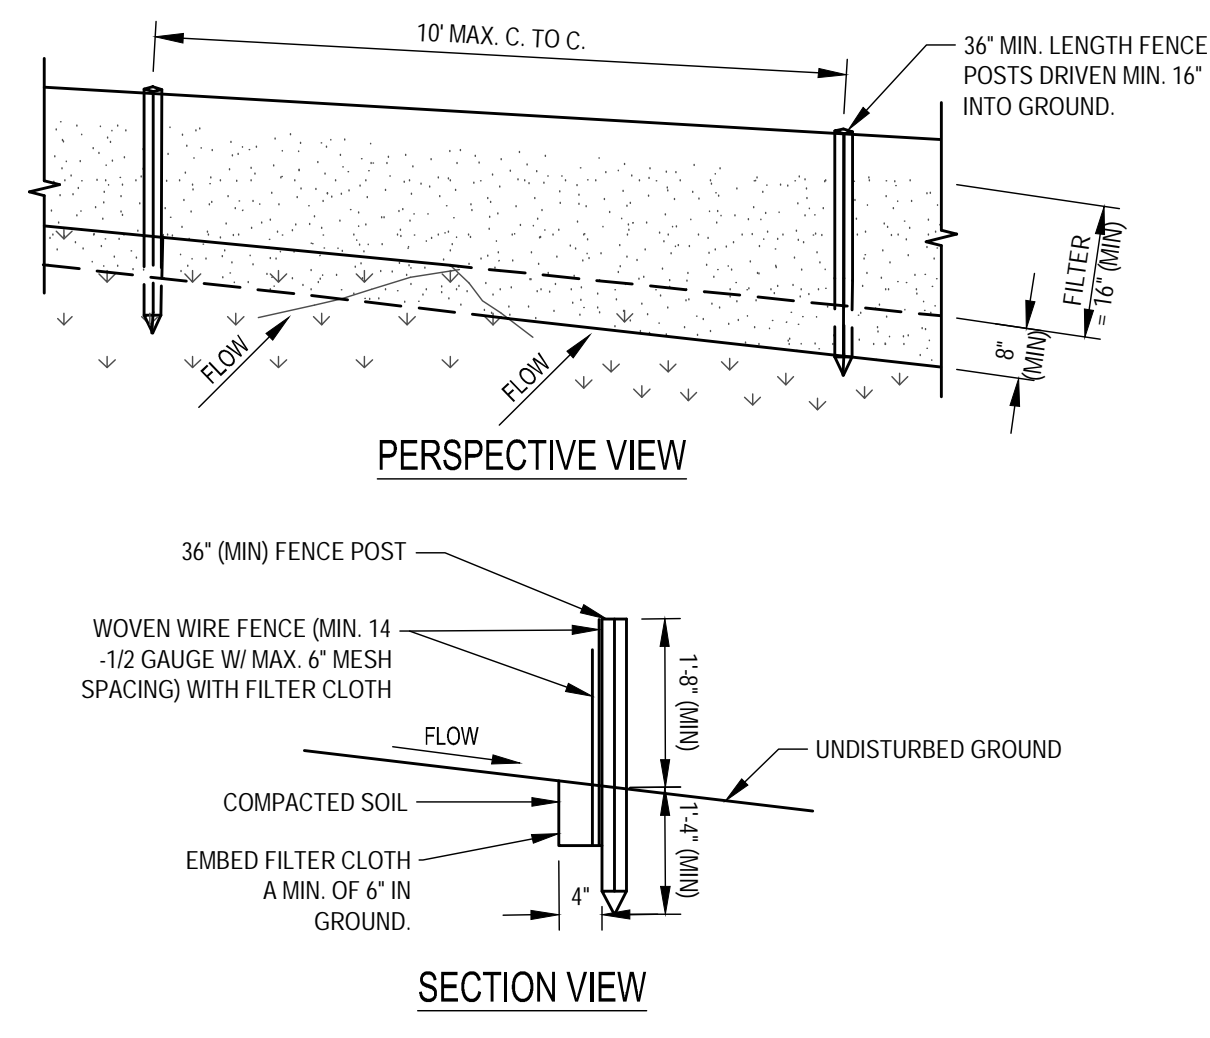

CONSTRUCTION SPECIFICATIONS:

- POSTS SHALL BE STEEL EITHER "1" OR "1/2" TYPE OR HARDWOOD.
- WHEN TWO SECTIONS OF FILTER CLOTH ADJOIN EACH OTHER THEY SHALL BE OVER-LAPPED BY SIX INCHES AND FOLDED. FILTER CLOTH SHALL BE EITHER FILTER X, MIRA1 100, STABILINKA T14IN, OR APPROVED EQUIVALENT.
- PREFABRICATED UNITS SHALL BE GEOFAB, ENVIROFENCE, OR APPROVED EQUIVALENT.
- MAINTENANCE SHALL BE PERFORMED AS NEEDED AND MATERIAL REMOVED WHEN "BULGES" DEVELOP IN THE SILT FENCE.


1 SILT FENCE DETAIL
L-501 SCALE: NONE

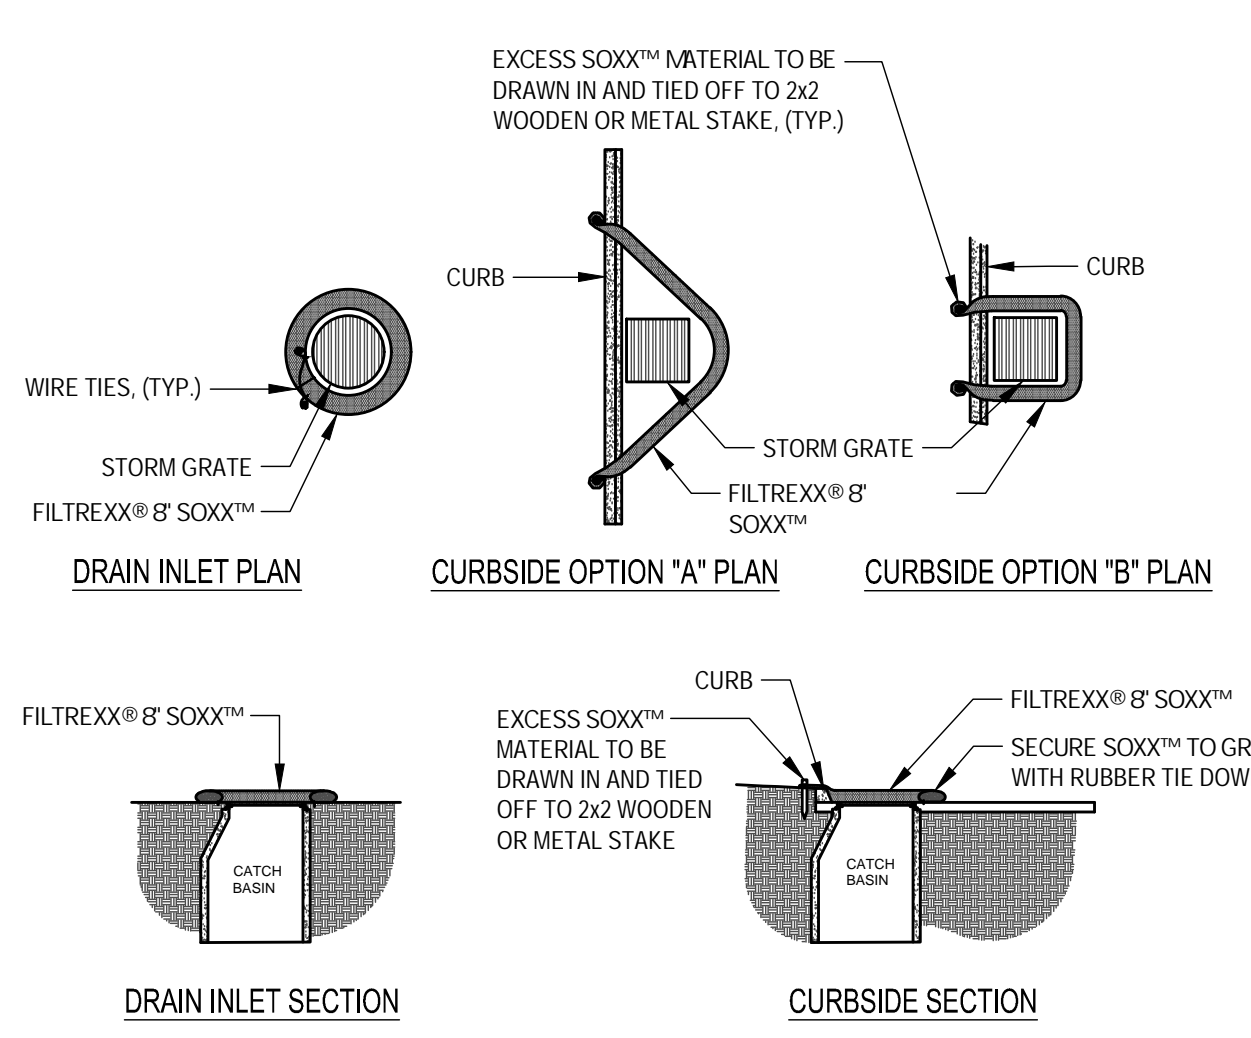

NOTES:

- ALL MATERIAL TO MEET FILTREXX® SPECIFICATIONS.
- FILTER MEDIA™ FILL TO MEET APPLICATION REQUIREMENTS.
- COMPOST MATERIAL TO BE DISPERSED ON SITE, AS DETERMINED BY ENGINEER.


2 FILTER SOCK INLET PROTECTION DETAIL
L-501 SCALE: NONE

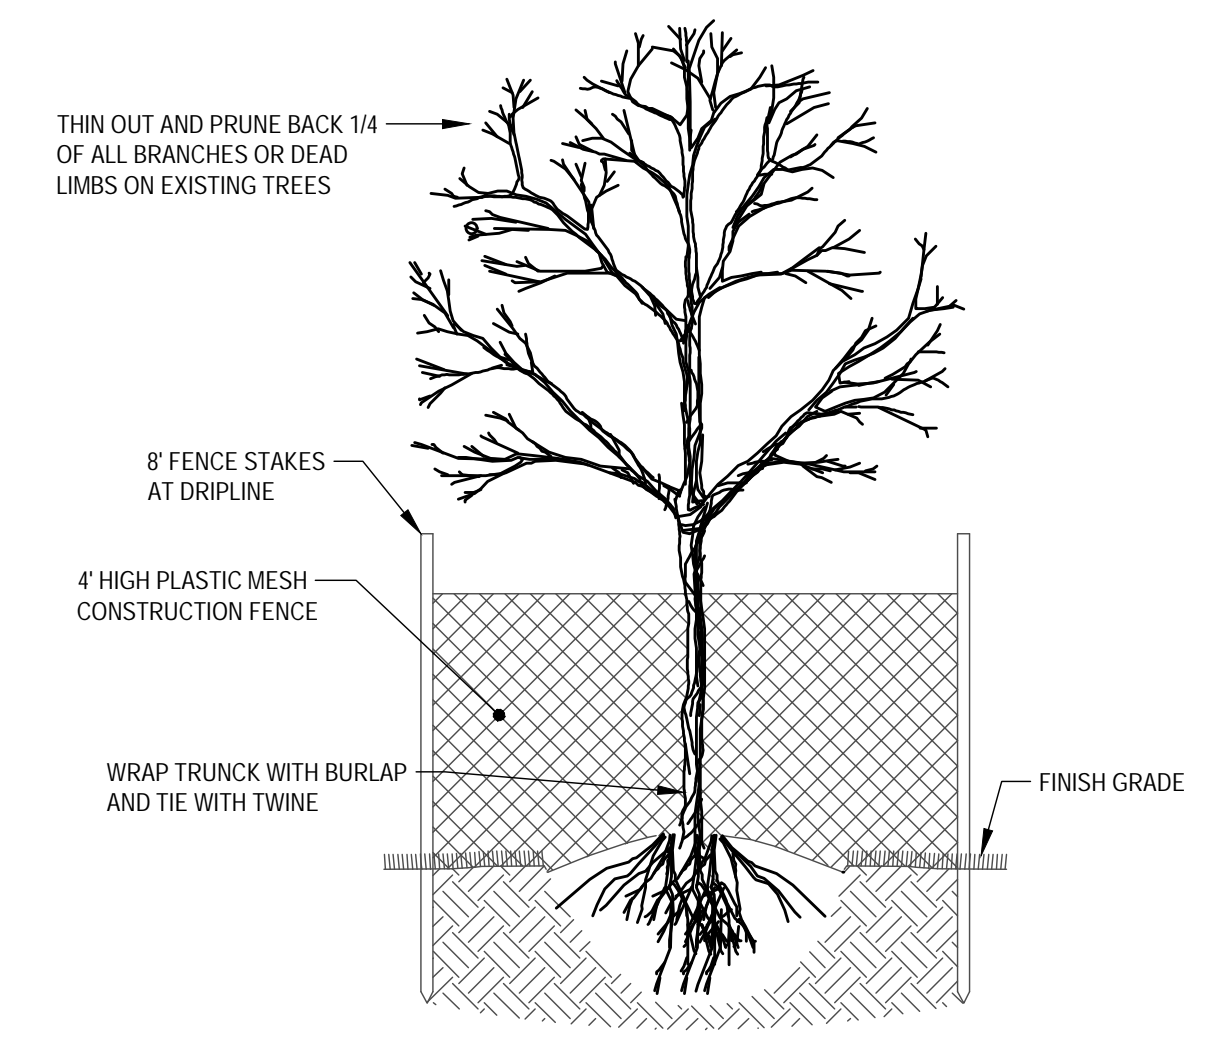


NOTES:

- THIS DETAIL SHALL BE USED FOR EVERY TREE INTENDED TO REMAIN WITHIN THE PROJECT LIMITS. PROJECT LIMITS ARE SHOWN ON SHEET C-XXX.
- CONTRACTOR TO MAINTAIN TREE PROTECTIVE BARRIER THROUGHOUT THE DURATION OF THE PROJECT.


3 TREE PROTECTION FENCE DETAIL
L-501 SCALE: NONE

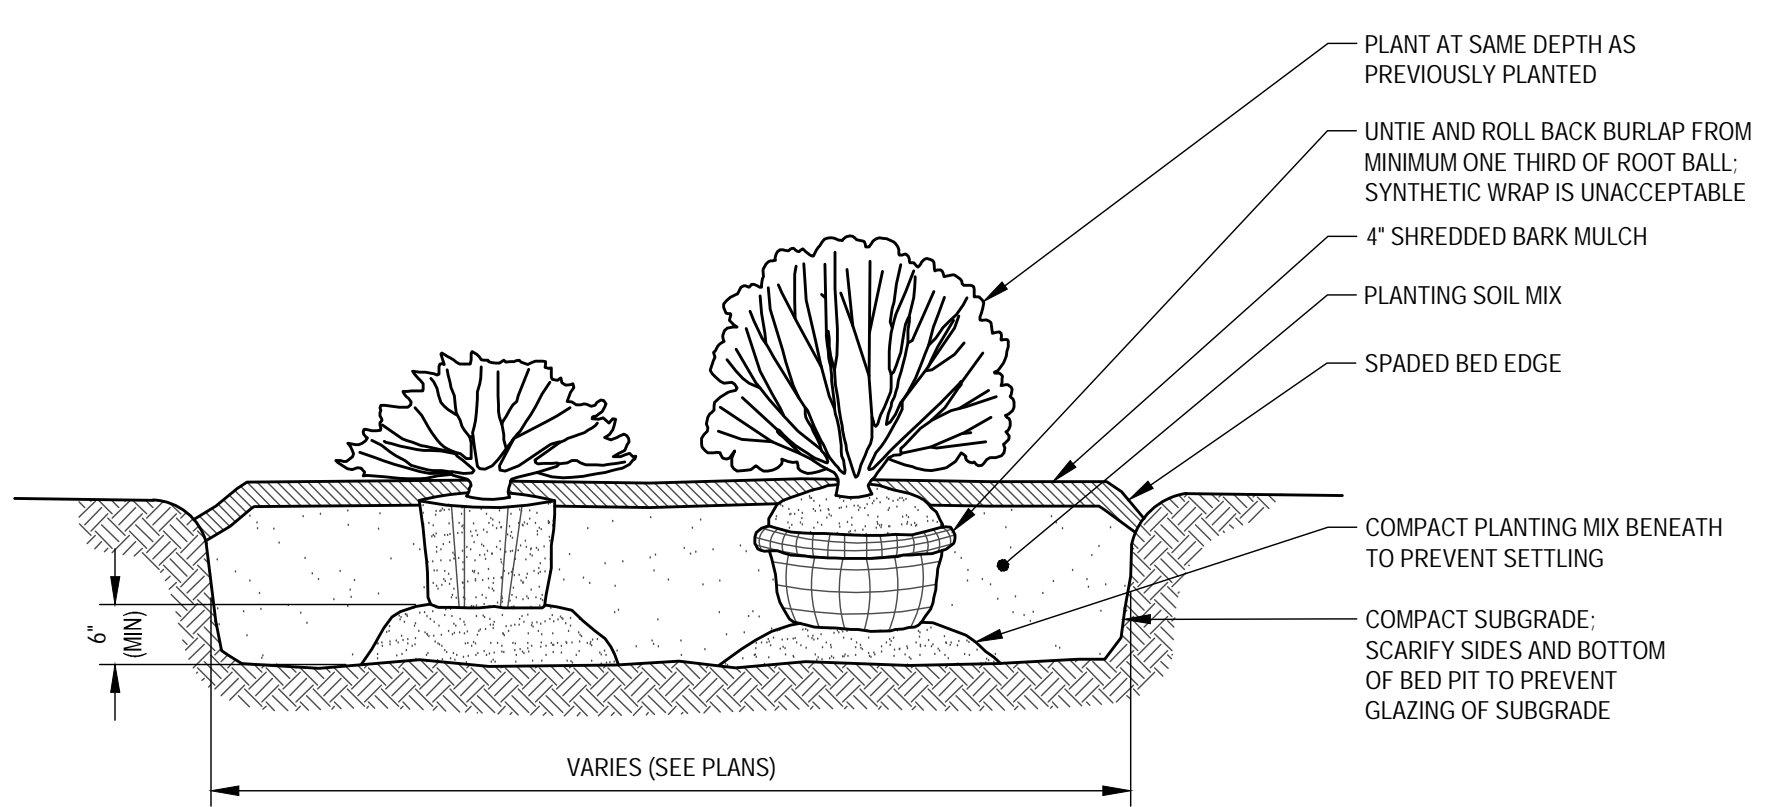


5 SHRUB PLANTING DETAIL
L-501 SCALE: NONE

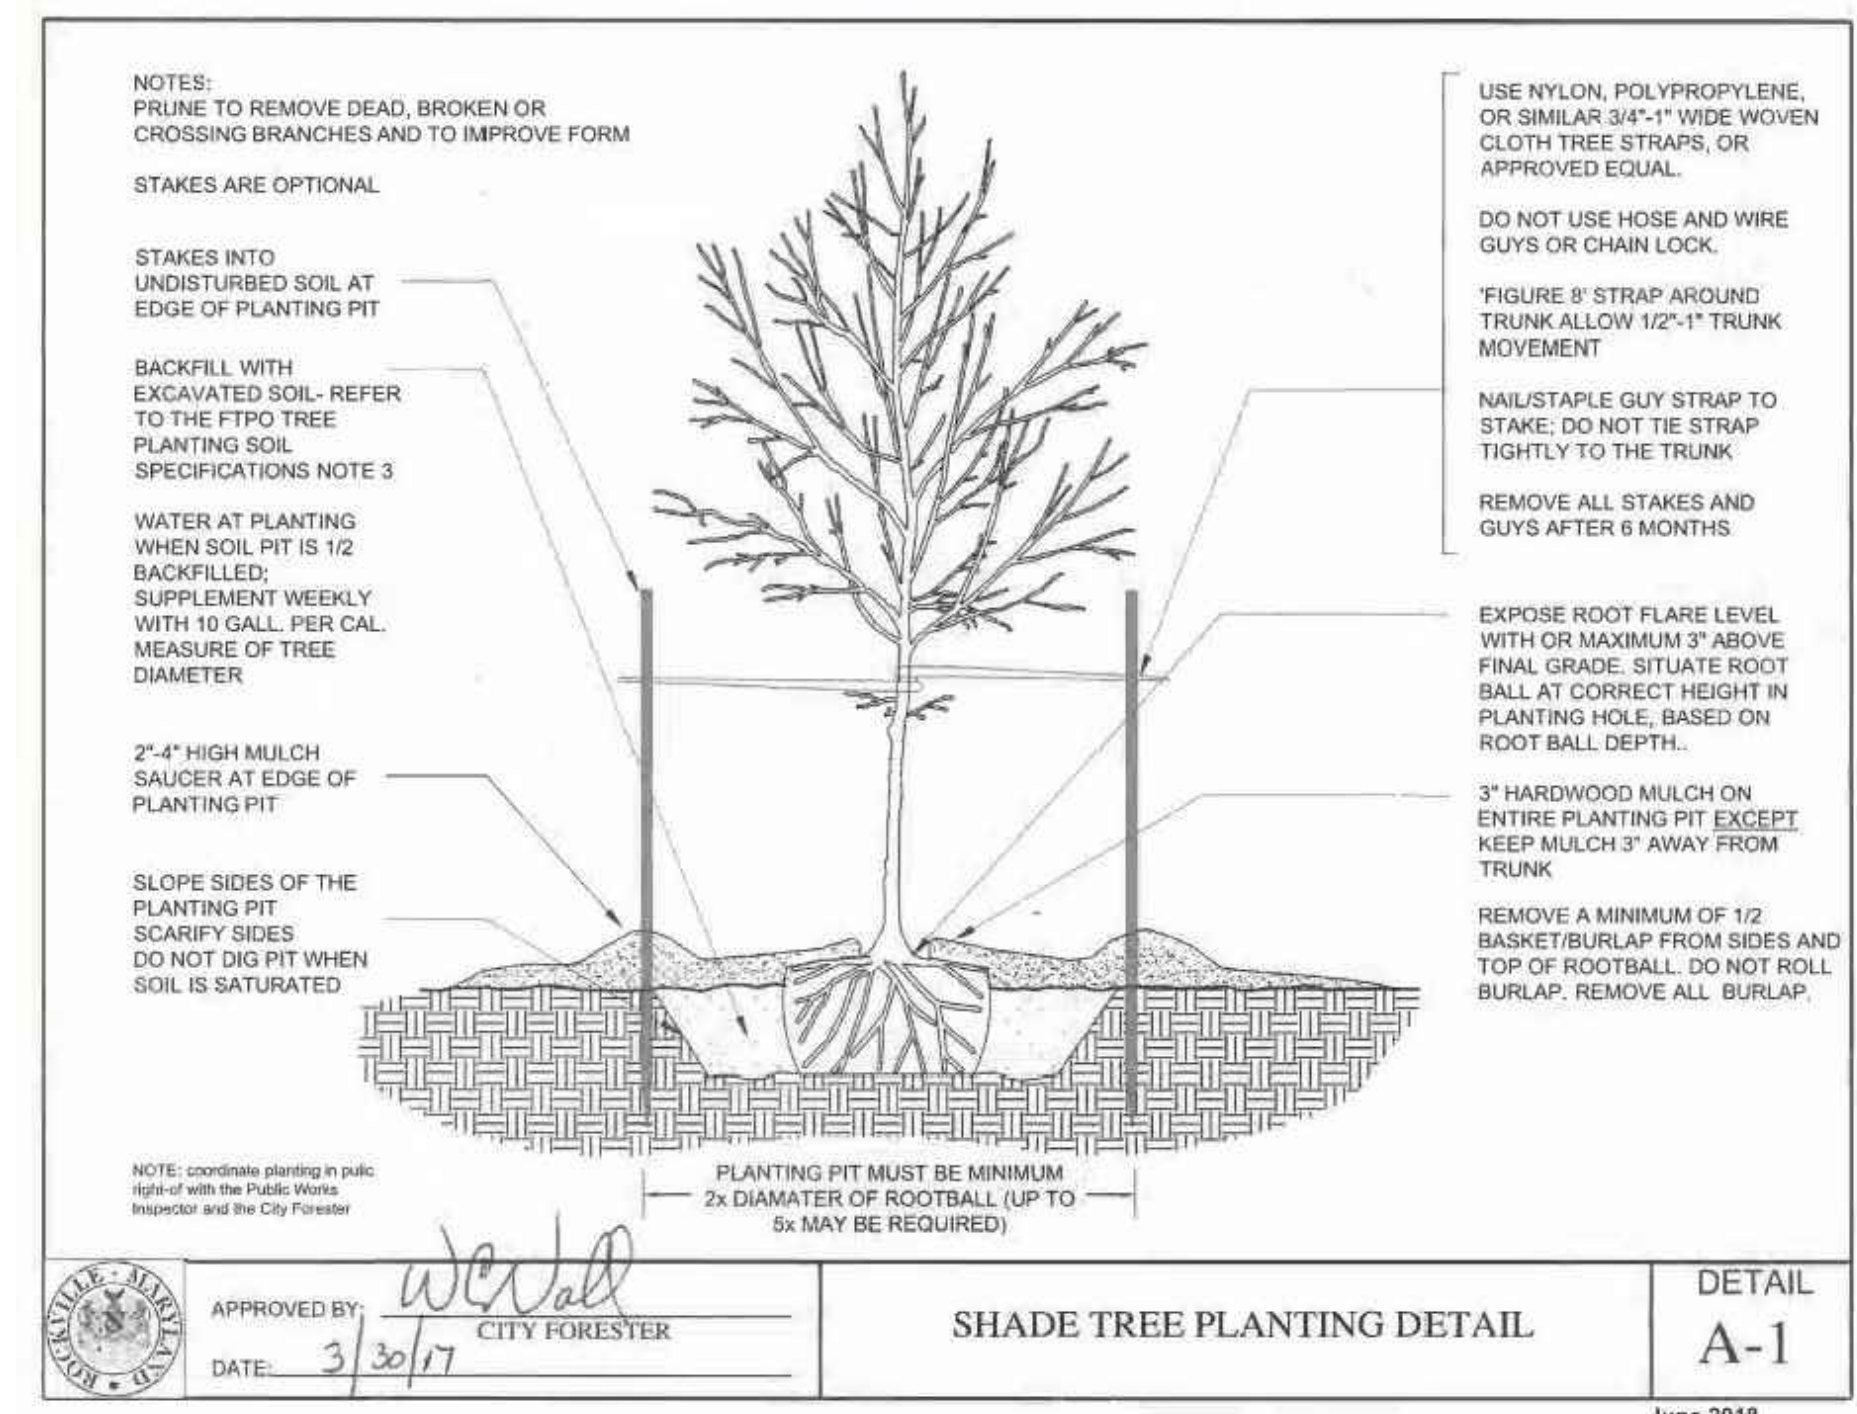


A-1 SHADE TREE PLANTING DETAIL - CITY OF ROCKVILLE
L-501 SCALE: NONE

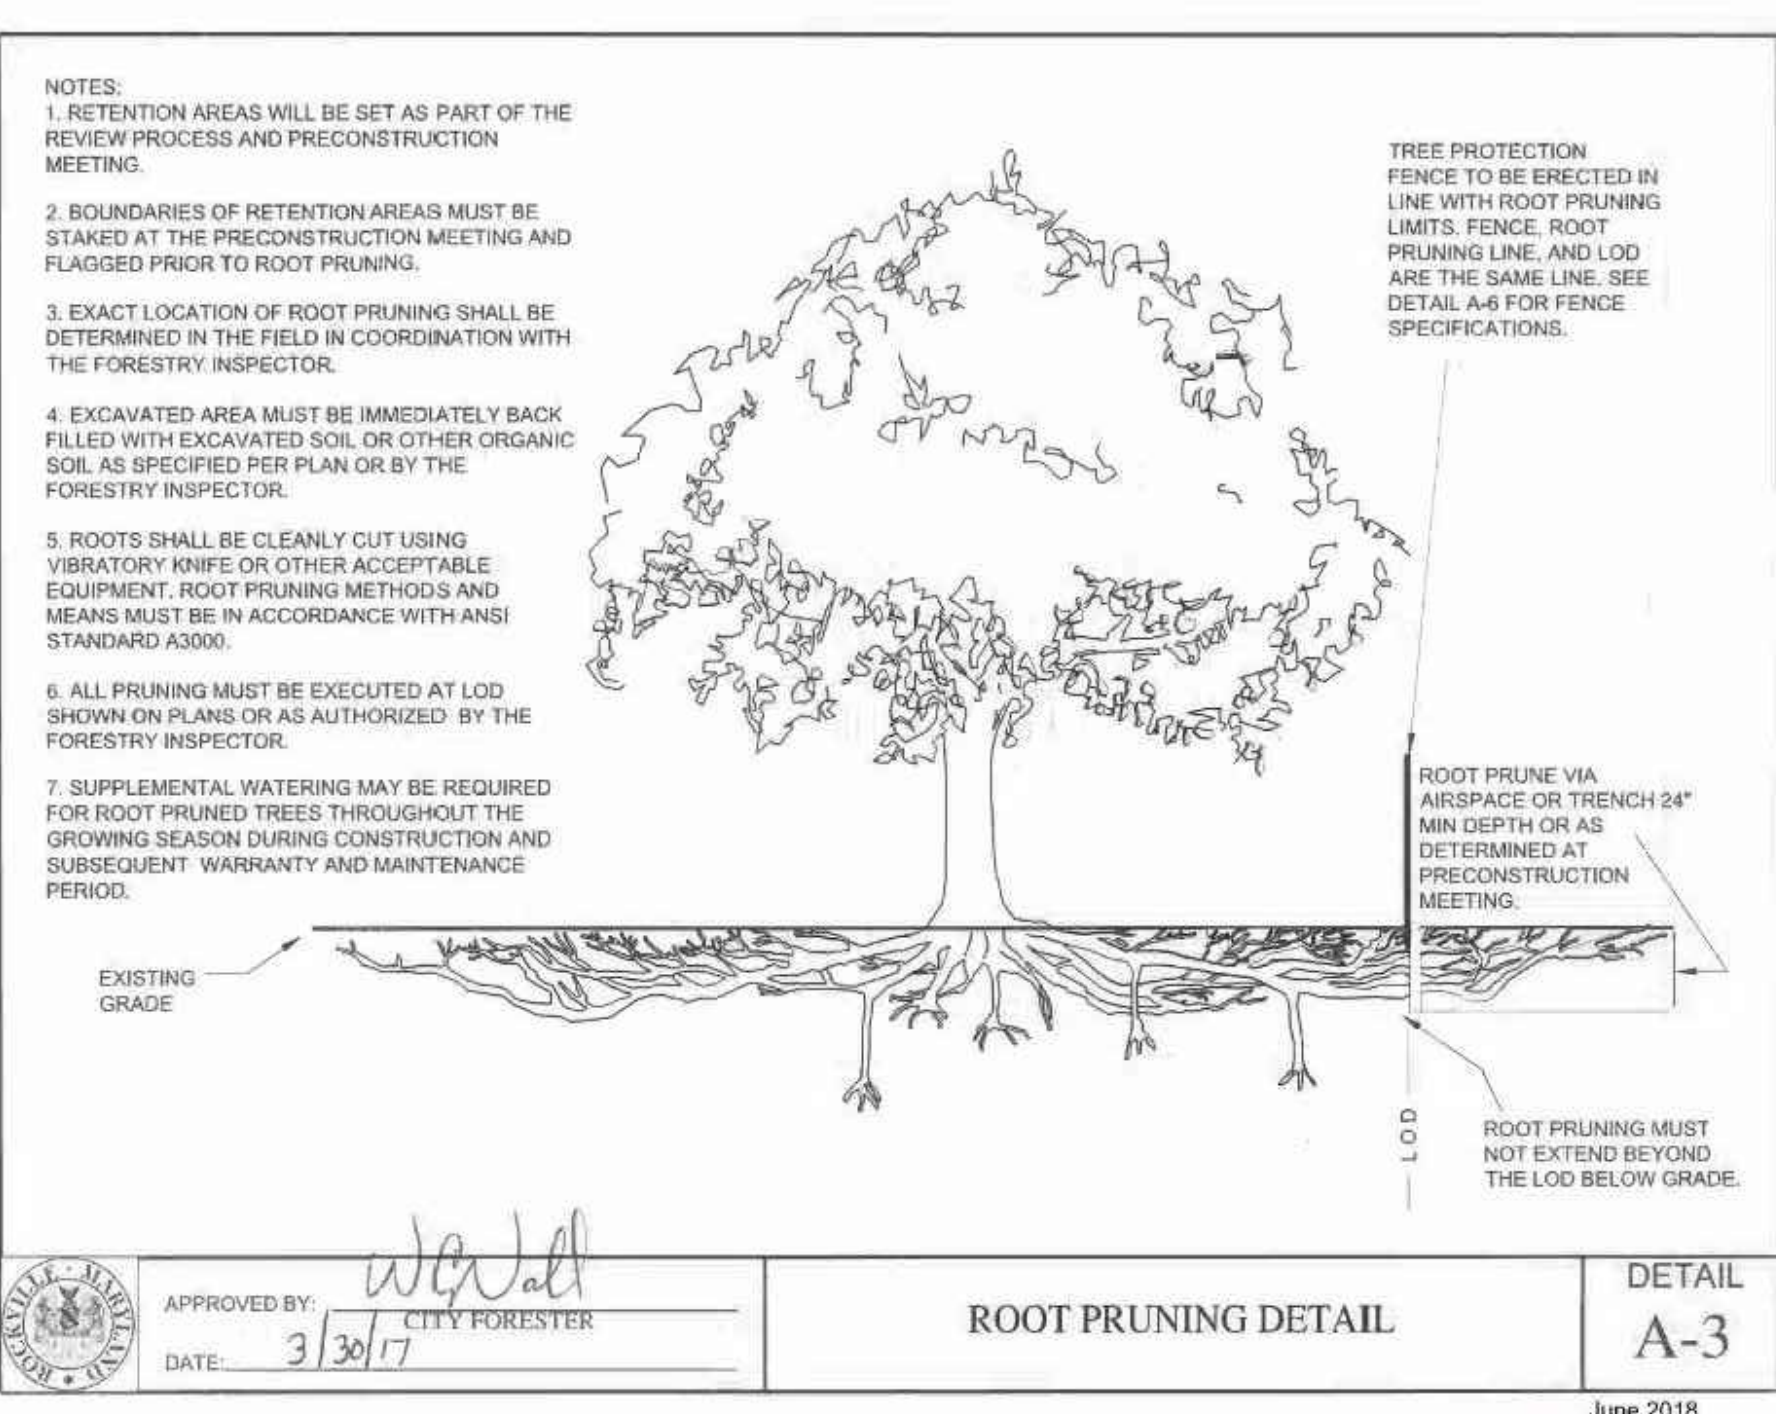


A-3 ROOT PRUNING DETAIL - CITY OF ROCKVILLE
L-501 SCALE: NONE

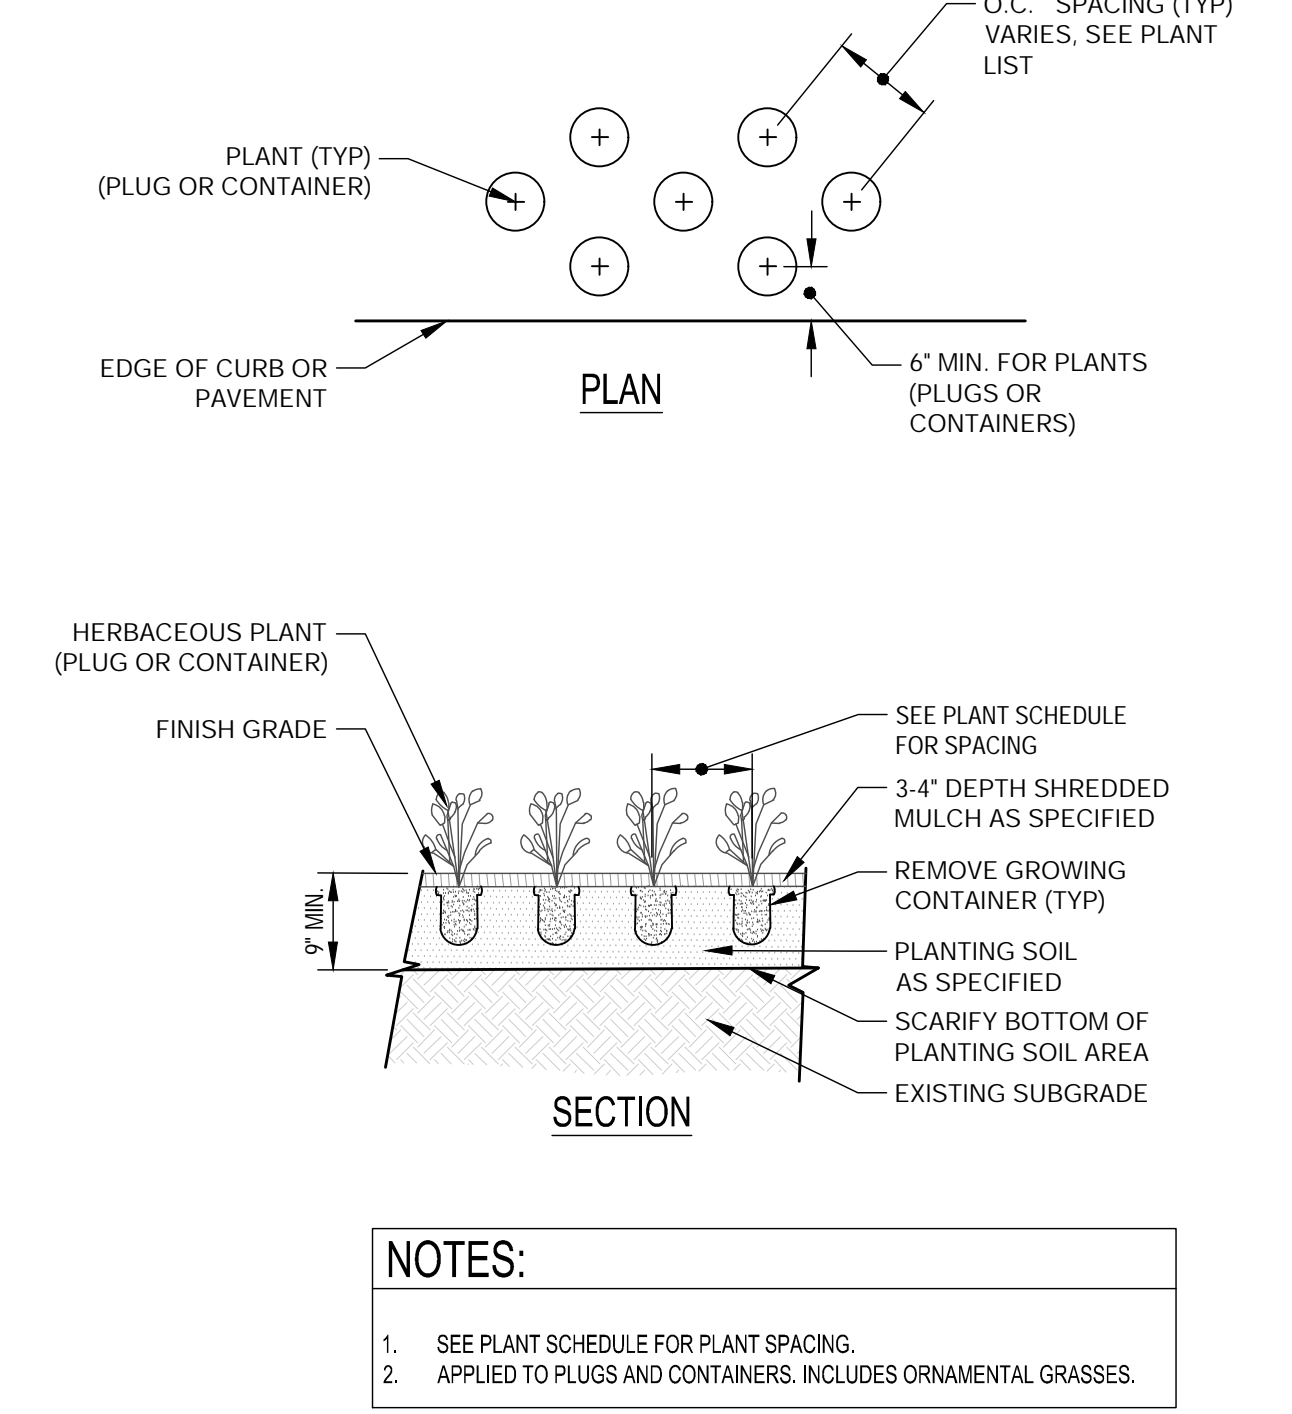


6 PLUG PLANTING DETAIL
L-501 SCALE: NONE

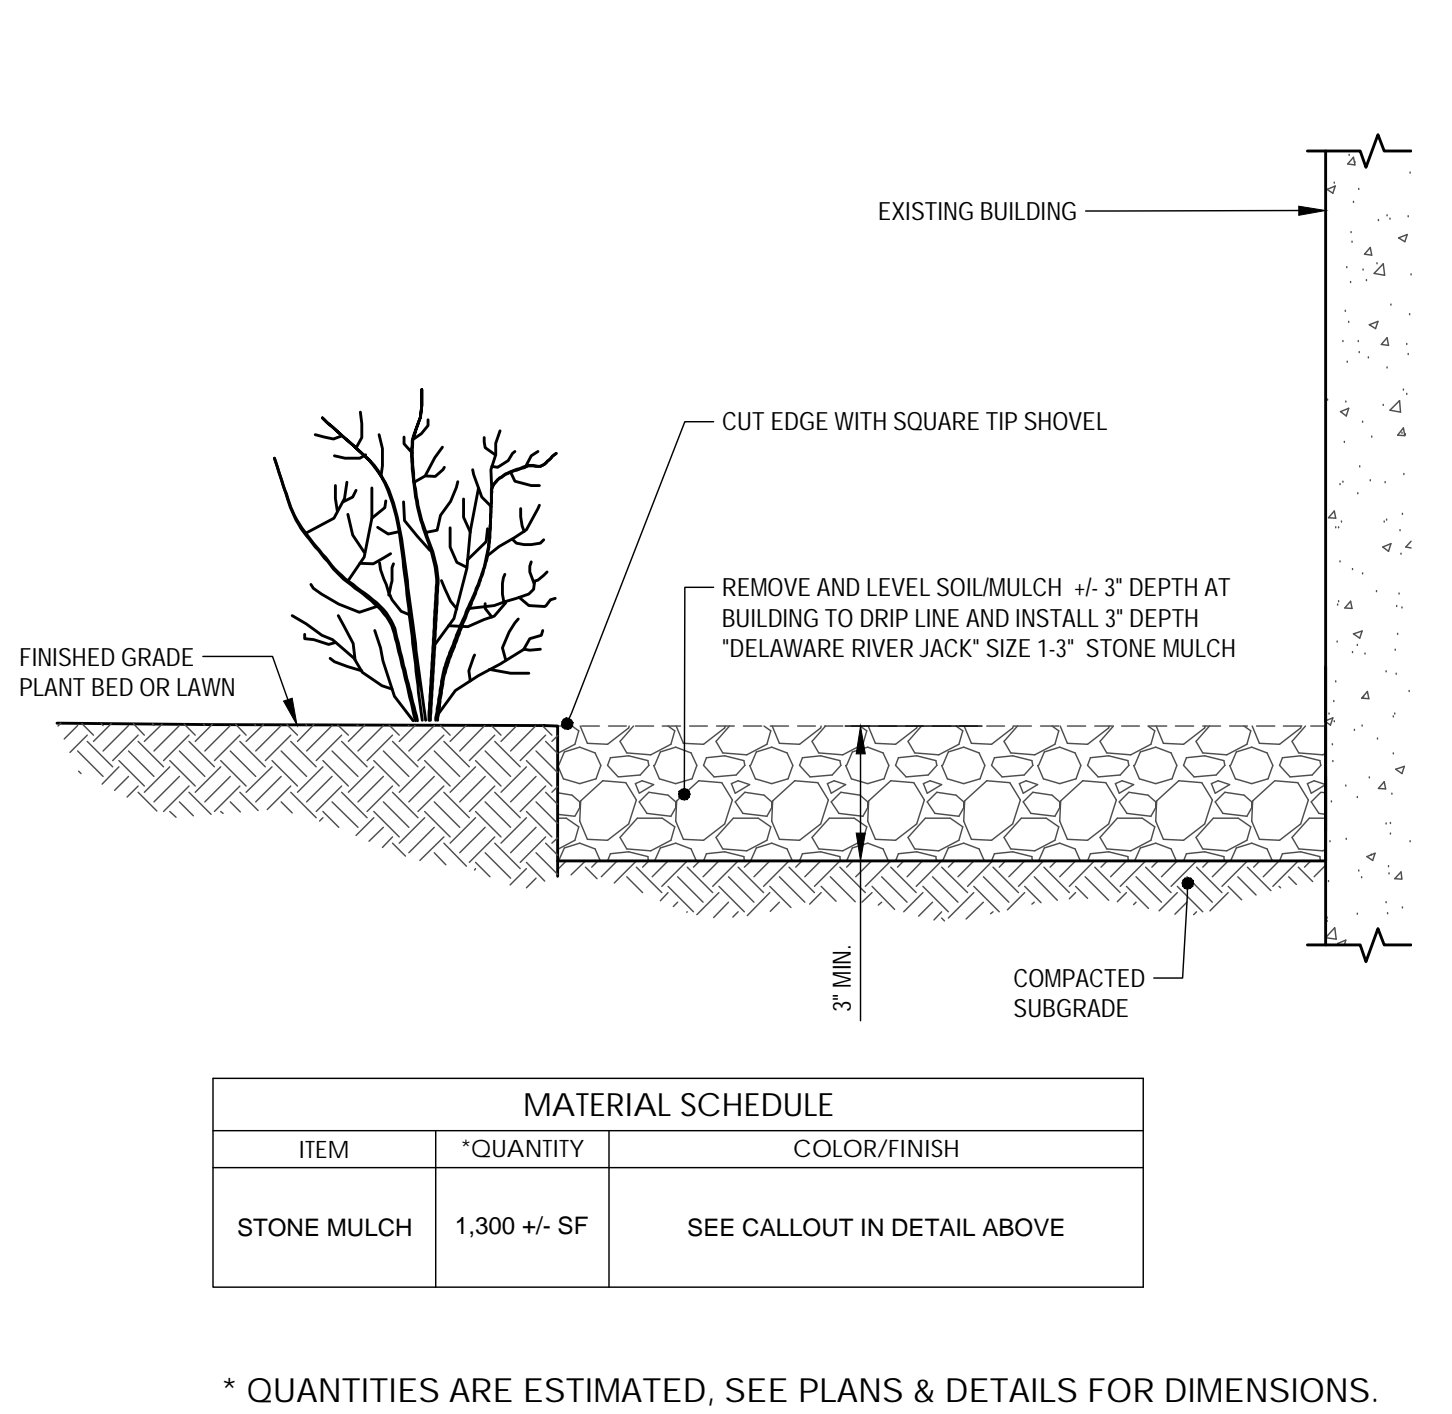

7 STONE MULCH AT BUILDING PERIMETER
L-501 SCALE: NONE

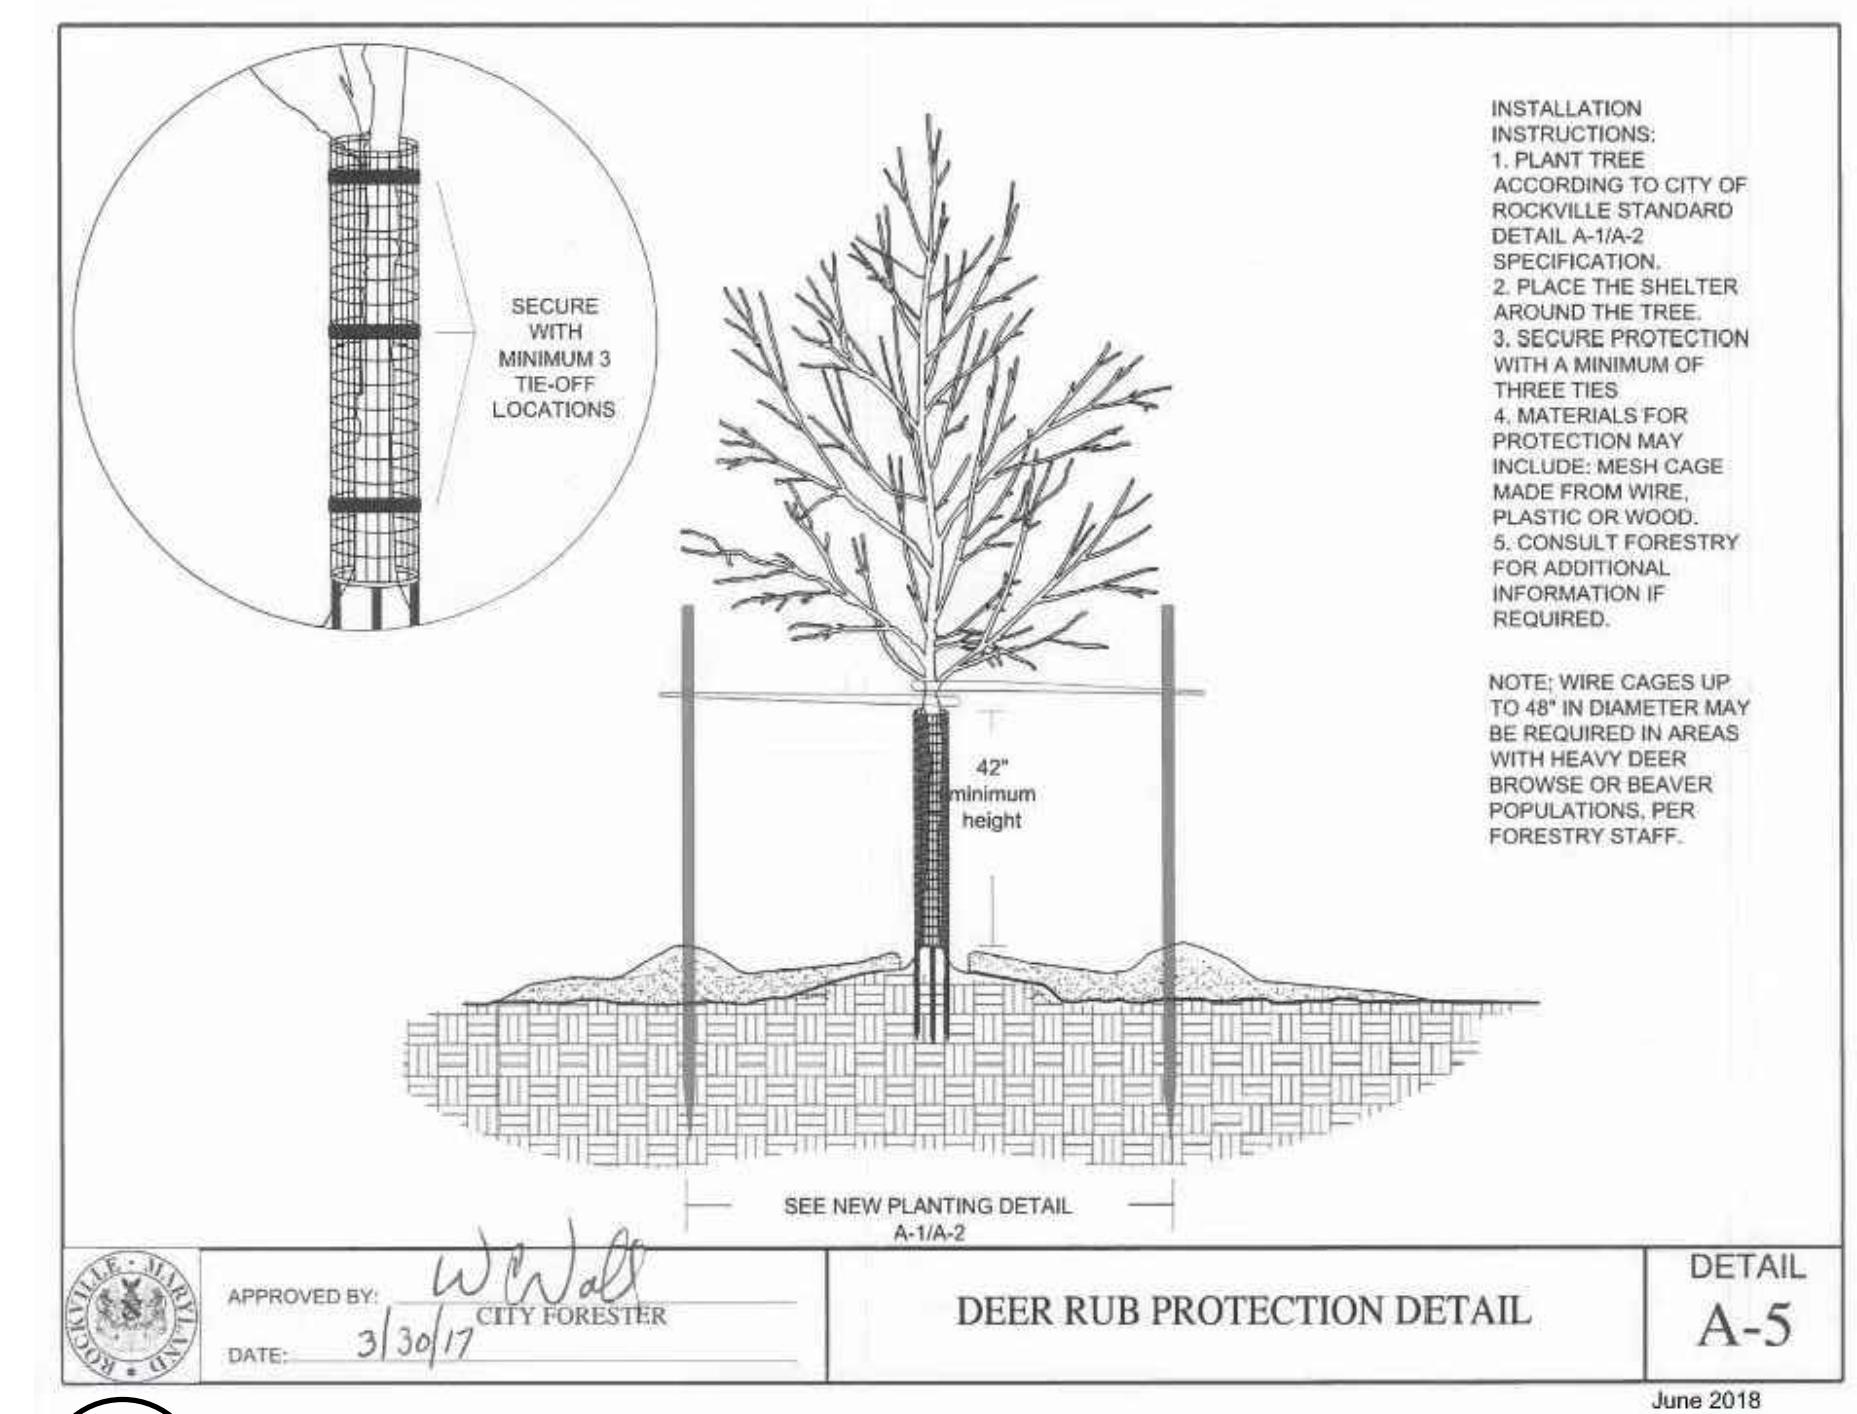


A-5 DEER RUB PROTECTION DETAIL - CITY OF ROCKVILLE
L-501 SCALE: NONE

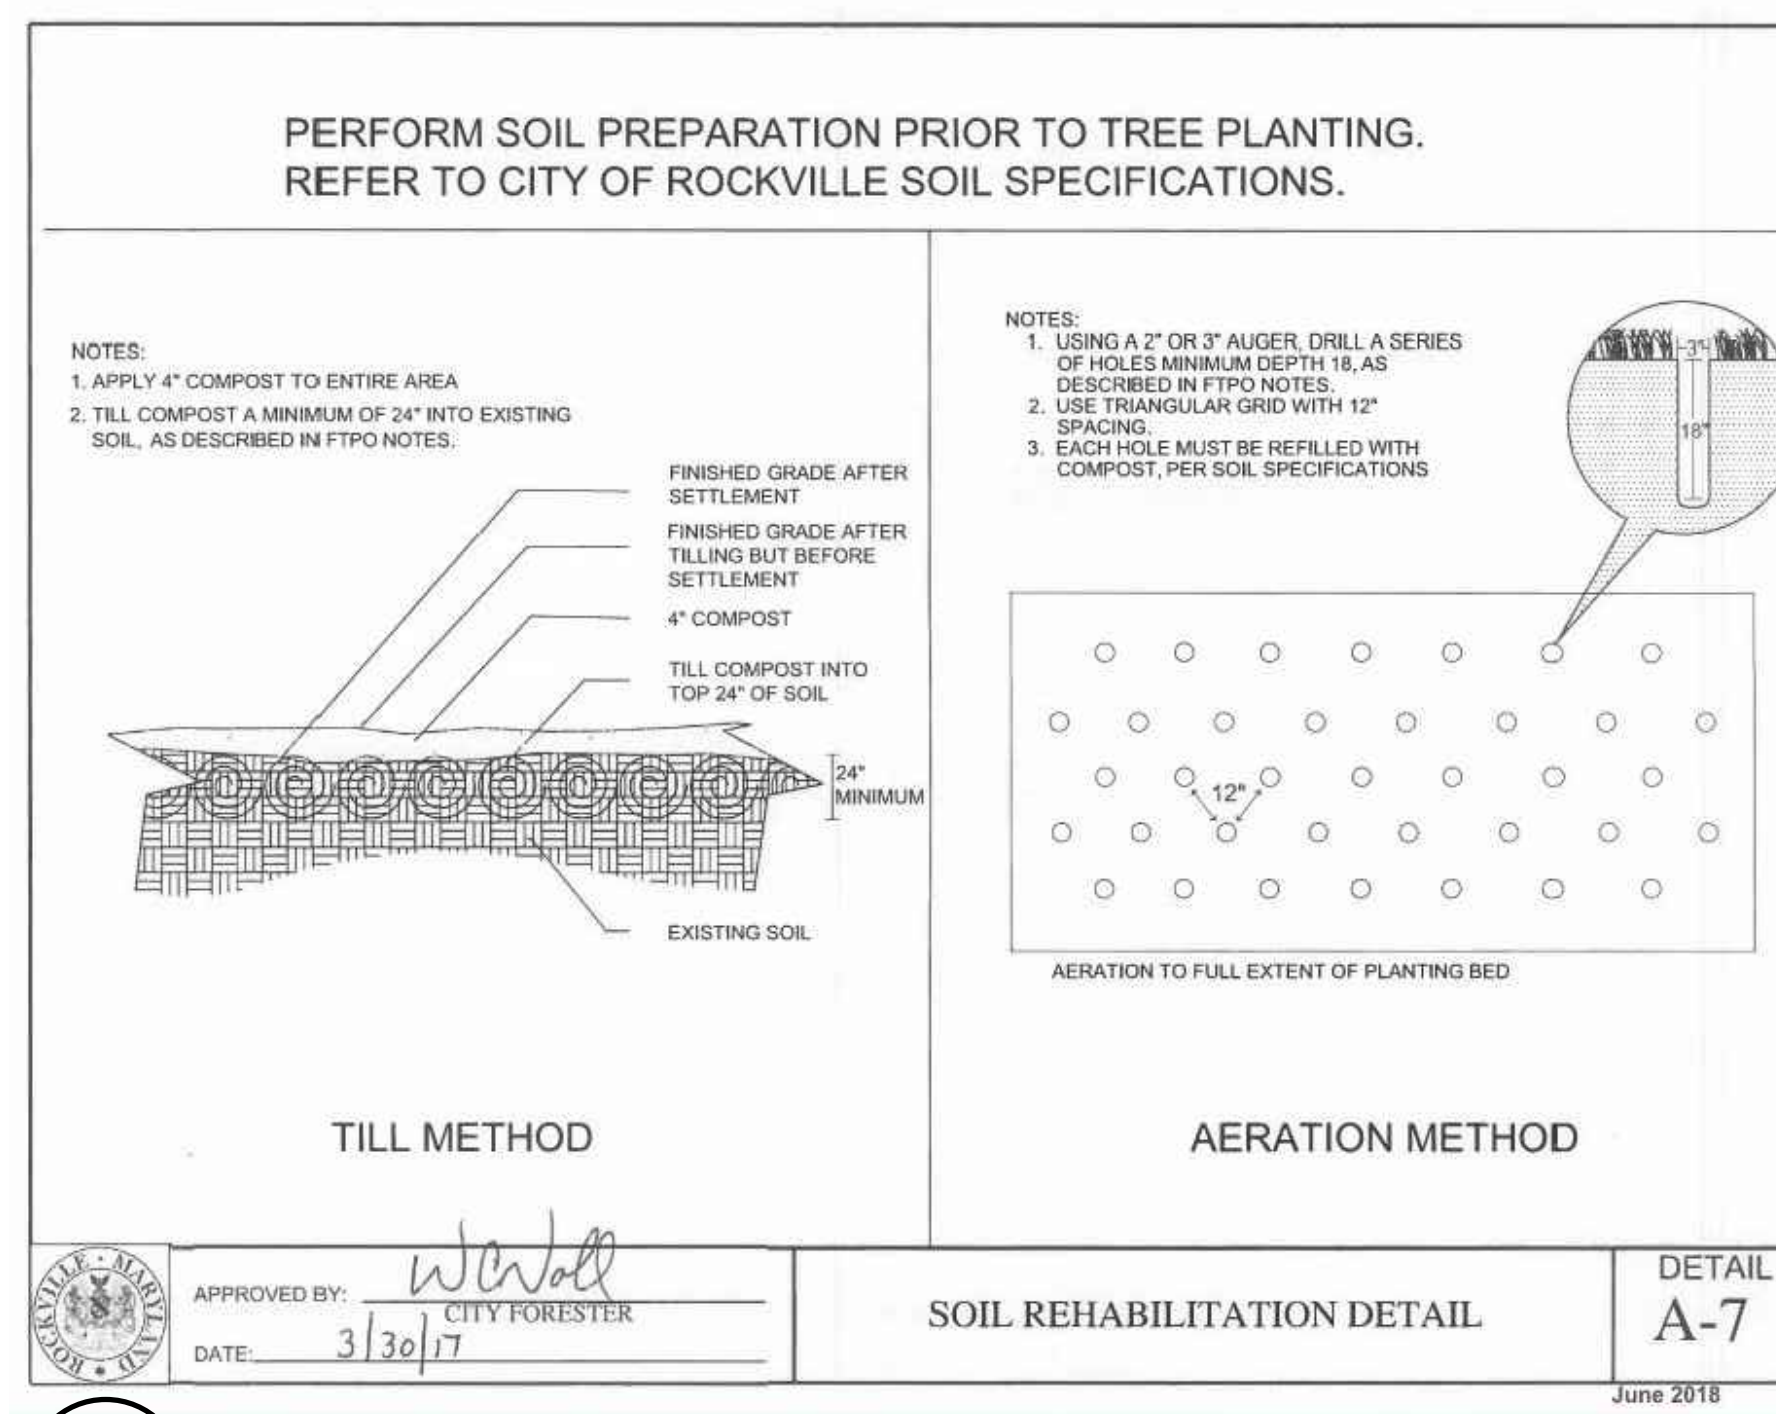

A-7 SOIL REHABILITATION DETAIL - CITY OF ROCKVILLE
L-501 SCALE: NONE

Key Plan

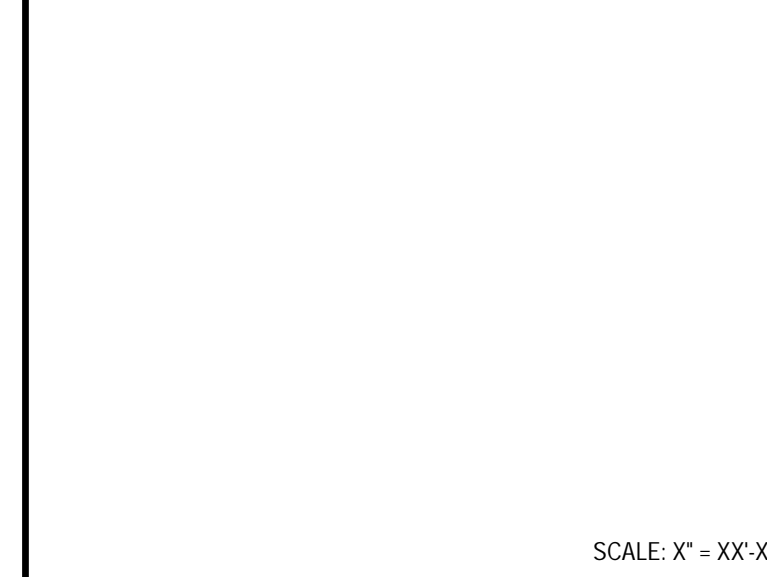

No.	Revision	Date

Project Name
**CITY OF ROCKVILLE
6 TAFT COURT RENOVATION**

ROCKVILLE MARYLAND

DELTA
ENGINEERS, ARCHITECTS, & SURVEYORS

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Tel: 301.718.0090
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www.delta-eas.com

Seal of the City of Rockville, Maryland




Phase
IFB SUBMISSION

Project No.
2019.331.004


Date
2022.02.18

Drawing Title
SITE DETAILS


Drawing No.
L-501

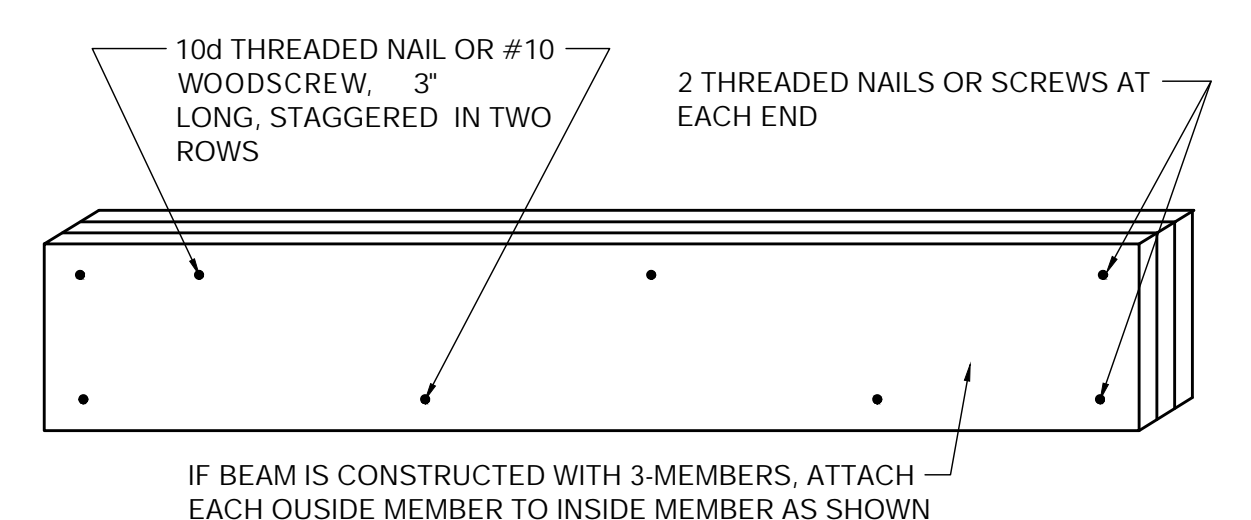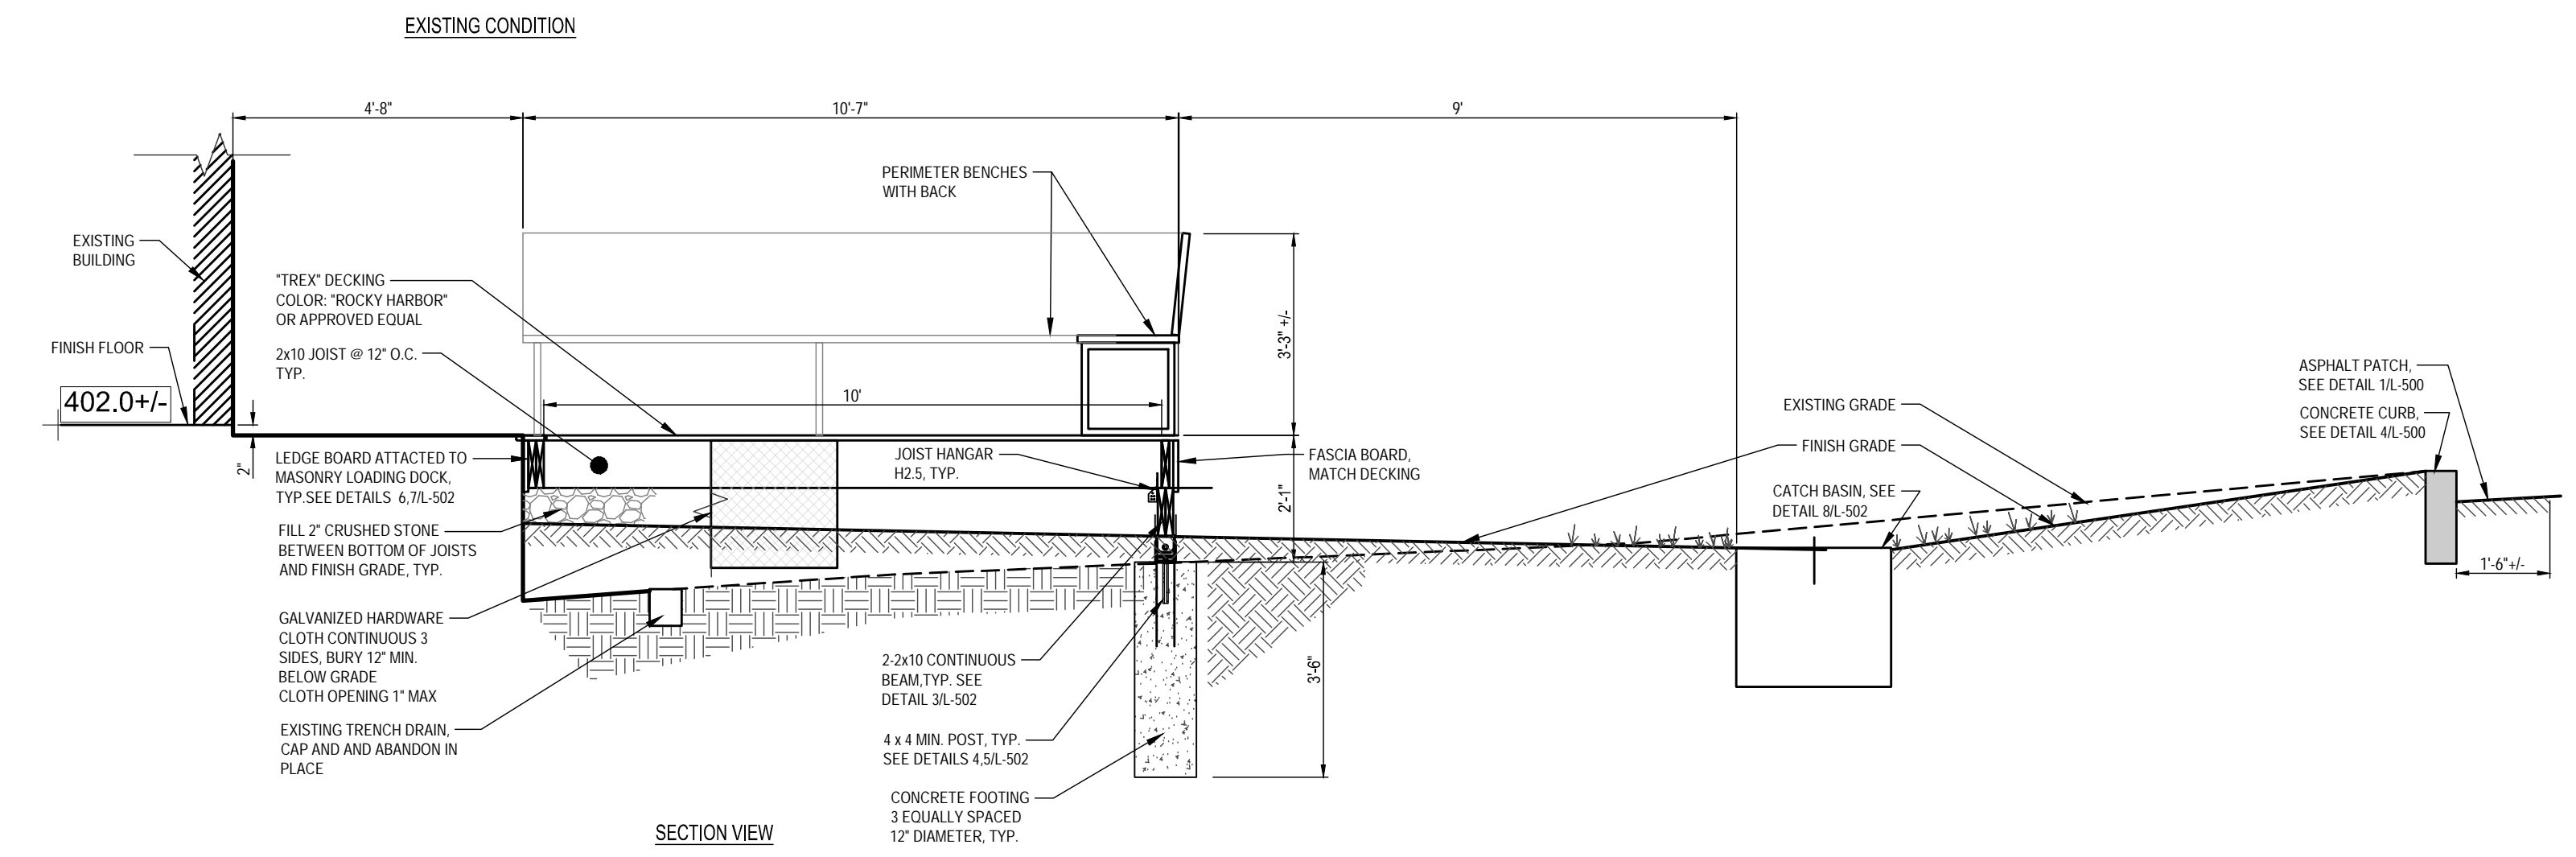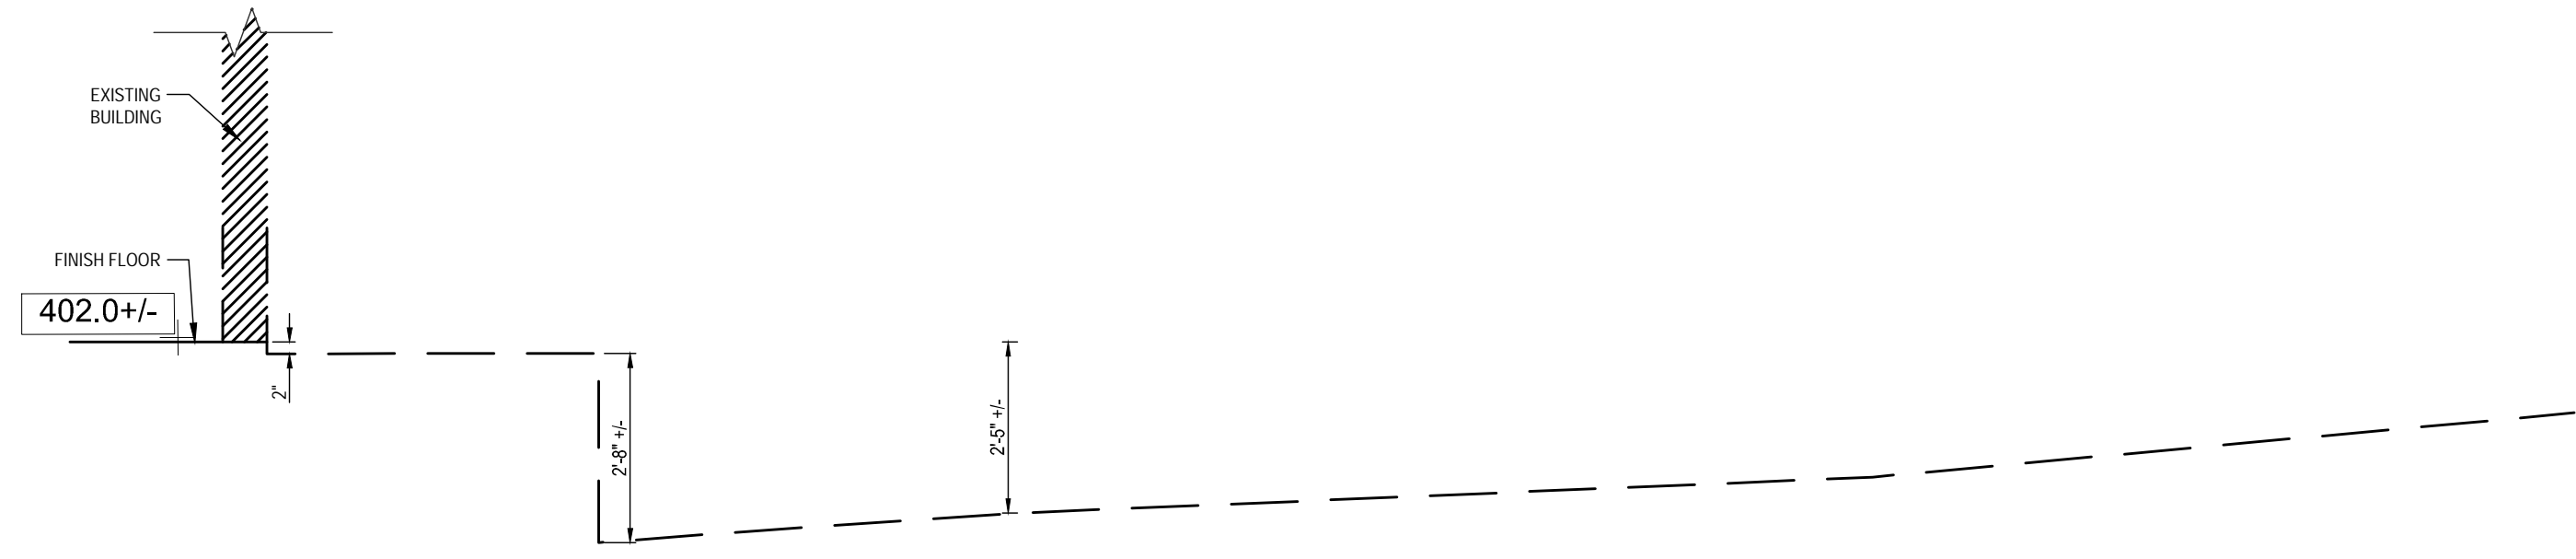


3 BEAM ASSEMBLY, TYP.
SCALE: NONE

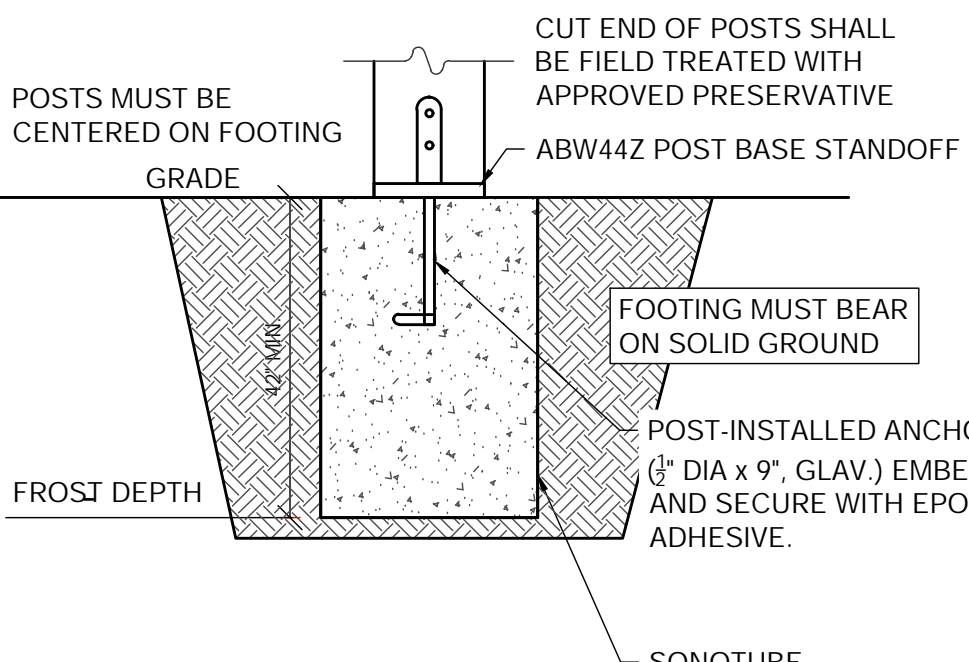


4 POST FOOTING, TYP.
SCALE: NONE

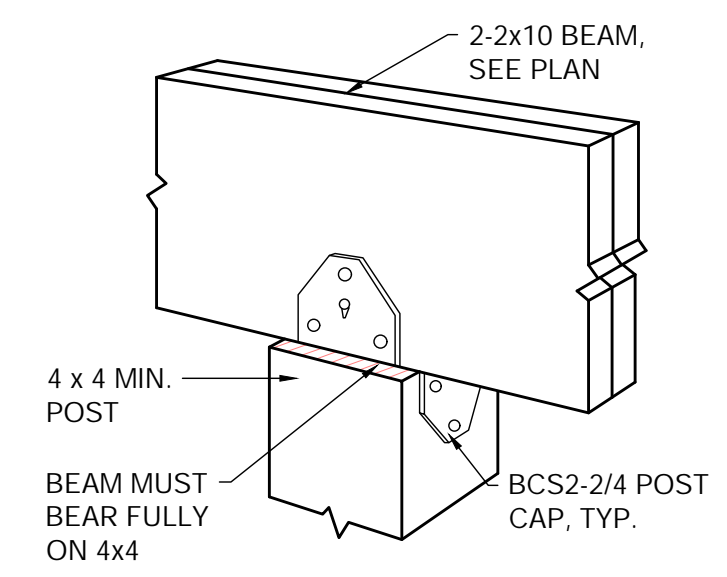

5 POST-TO-BEAM ATTACHMENT, TYP.
SCALE: NONE

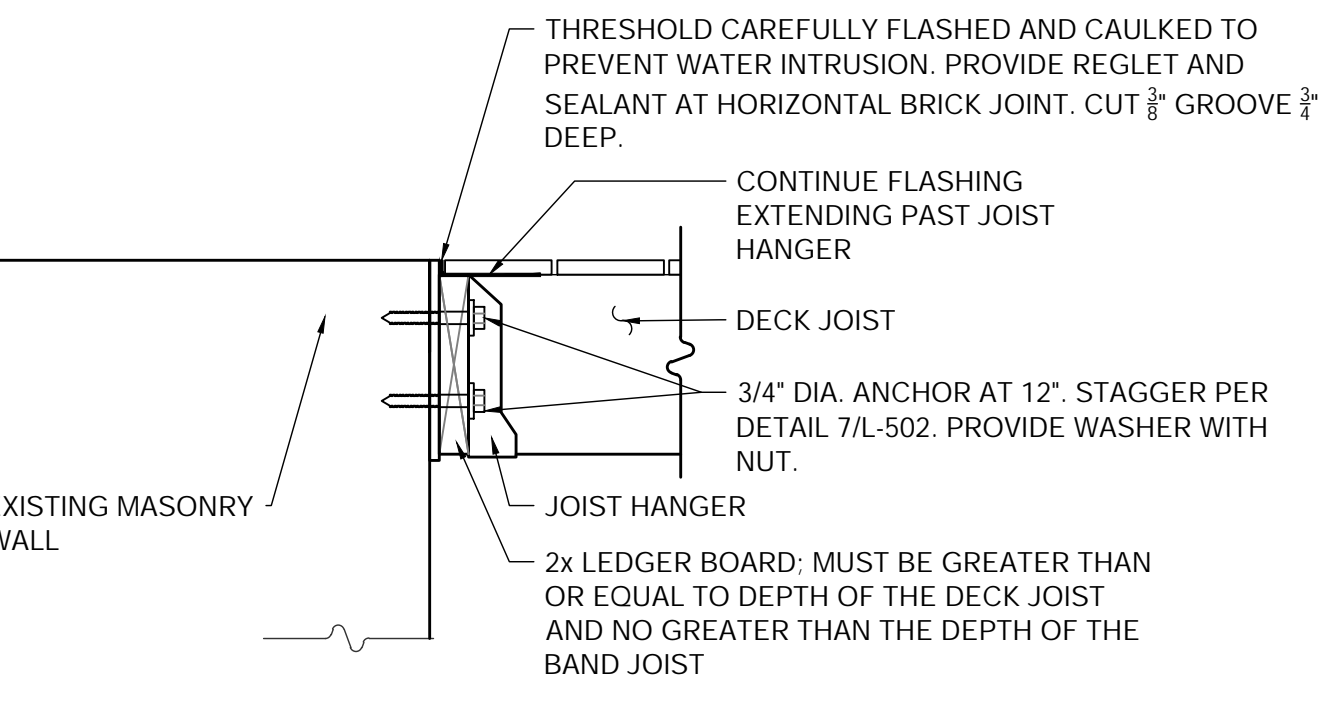

6 LEDGER BOARD ATTACHMENT, TYP.
SCALE: NONE

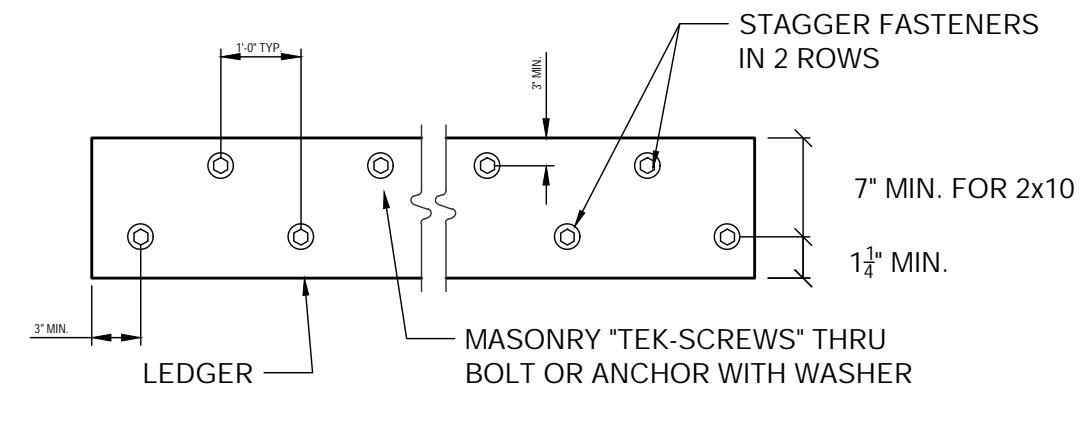


7 LEDGER BOARD FASTENER SPACING & CLEARANCE, TYP.
SCALE: NONE

- DECK FRAME NOTES:**
- FRAME AND INSTALL DECK. ORIENT JOISTS PERPENDICULAR TO HOUSE. SPACED 12" O.C. UNLESS NOTED (SEE ADDITIONAL NOTES BELOW). ATTACH JOISTS ON TOP OF BEAMS WITH 3-8d THREADED TOE NAILS (2 ON ONE SIDE, 1 ON THE OTHER) AND ATTACH JOIST TO LEDGER WITH JOIST HANGERS. CONNECTIONS MUST ALSO RESIST LATERAL AND UPLIFT FORCES. BLOCKING OR FRAMING IS ALSO REQUIRED TO PREVENT OVERTURNING OF JOISTS.
 - ALL LUMBER SHALL BE PRESSURE TREATED (PT) SOUTHERN PINE, #2 OR BETTER.
 - FOOTING SIZE TO BE MIN. 12" DIA. UNLESS NOTED OTHERWISE, POURED WITH SONOTUBES TO MIN. 42" DEPTH BELOW FINISHED GRADE. ALL FOOTINGS SHALL BEAR ON SOLID GROUND.
 - ALL SUPPORTS SHALL BE 4x4 PT POSTS AND RATED FOR GROUND CONTACT.
 - WHEN ATTACHMENTS ARE MADE TO THE EXISTING HOUSE, IT SHALL BE CAPABLE OF SUPPORTING THE DECK. ATTACH 2x10 LEDGER BOARD TO EXISTING EXTERIOR WALL PER DETAILS (THIS SHEET). FLASHING IS REQUIRED AT ANY LEDGER BOARD CONNECTION TO A WALL AND SHALL BE COMPOSED OF COPPER (ATTACHED USING COPPER NAILS), STAINLESS STEEL, UV RESISTANT PLASTIC OR GALVANIZED STEEL COATED WITH 1.85 OZ/SF OF ZINC (G-185 COATING).
 - POSITION THE TOP OF THE DECK BELOW THRESHOLD STONE LEDGE. CONFIRM ELEVATION ON GRADING PLAN.
 - DECKING TO BE "TREX". COLOR: "ROCKY HARBOR". BREAKS IN DECKING PATTERN TO OCCUR AT JOISTS. CONSIDER DECORATIVE BOARDER TO AT PERIMETER OF DECK. DARKER TONE TIMBER TECH MAY BE USED AS PERIMETER BOARDER, COLOR: TO BE APPROVED BY OWNER.
 - SCREWS AND ANCHORS SHALL BE HOT DIPPED GALVANIZE OR STAINLESS STEEL. CONNECTORS INDICATED IN THESE DRAWINGS ARE MANUFACTURED BY SIMPSON STRONG-TIE. CONNECTORS IN DIRECT CONTACT WITH PT LUMBER SHALL HAVE THE "2-MAX" COATING OR OTHERWISE BE STAINLESS STEEL.

LAYOUT KEY NOTES: (ADD ALTERNATE #1)


1	NEW DECK, WOOD CONSTRUCTION, SEE DETAILS 1.7/L-502
2	NEW BENCHES WITH BACKS AT DECK PERIMETER
3	NEW CONCRETE CURB AND PAVEMENT PATCH SEE DETAILS 1 & 4/L-500
4	NEW CONCRETE PRECAST CATCH BASIN, TIE INTO EXISTING 8" STORM DRAIN, VERIFY SIZE AND LOCATION IN FIELD, GRADE TO DRAIN, SEE DETAIL 8/L-502.
5	NEW LAWN AREA
6	PLANT BED EDGE CUT WITH SQUARE TIP SHOVEL, TYPICAL

NOTE: SEE DEMOLITION PLAN SHEET L-140 FOR ADD ALTERNATE #1 REMOVALS CALLOUTS AND NOTES

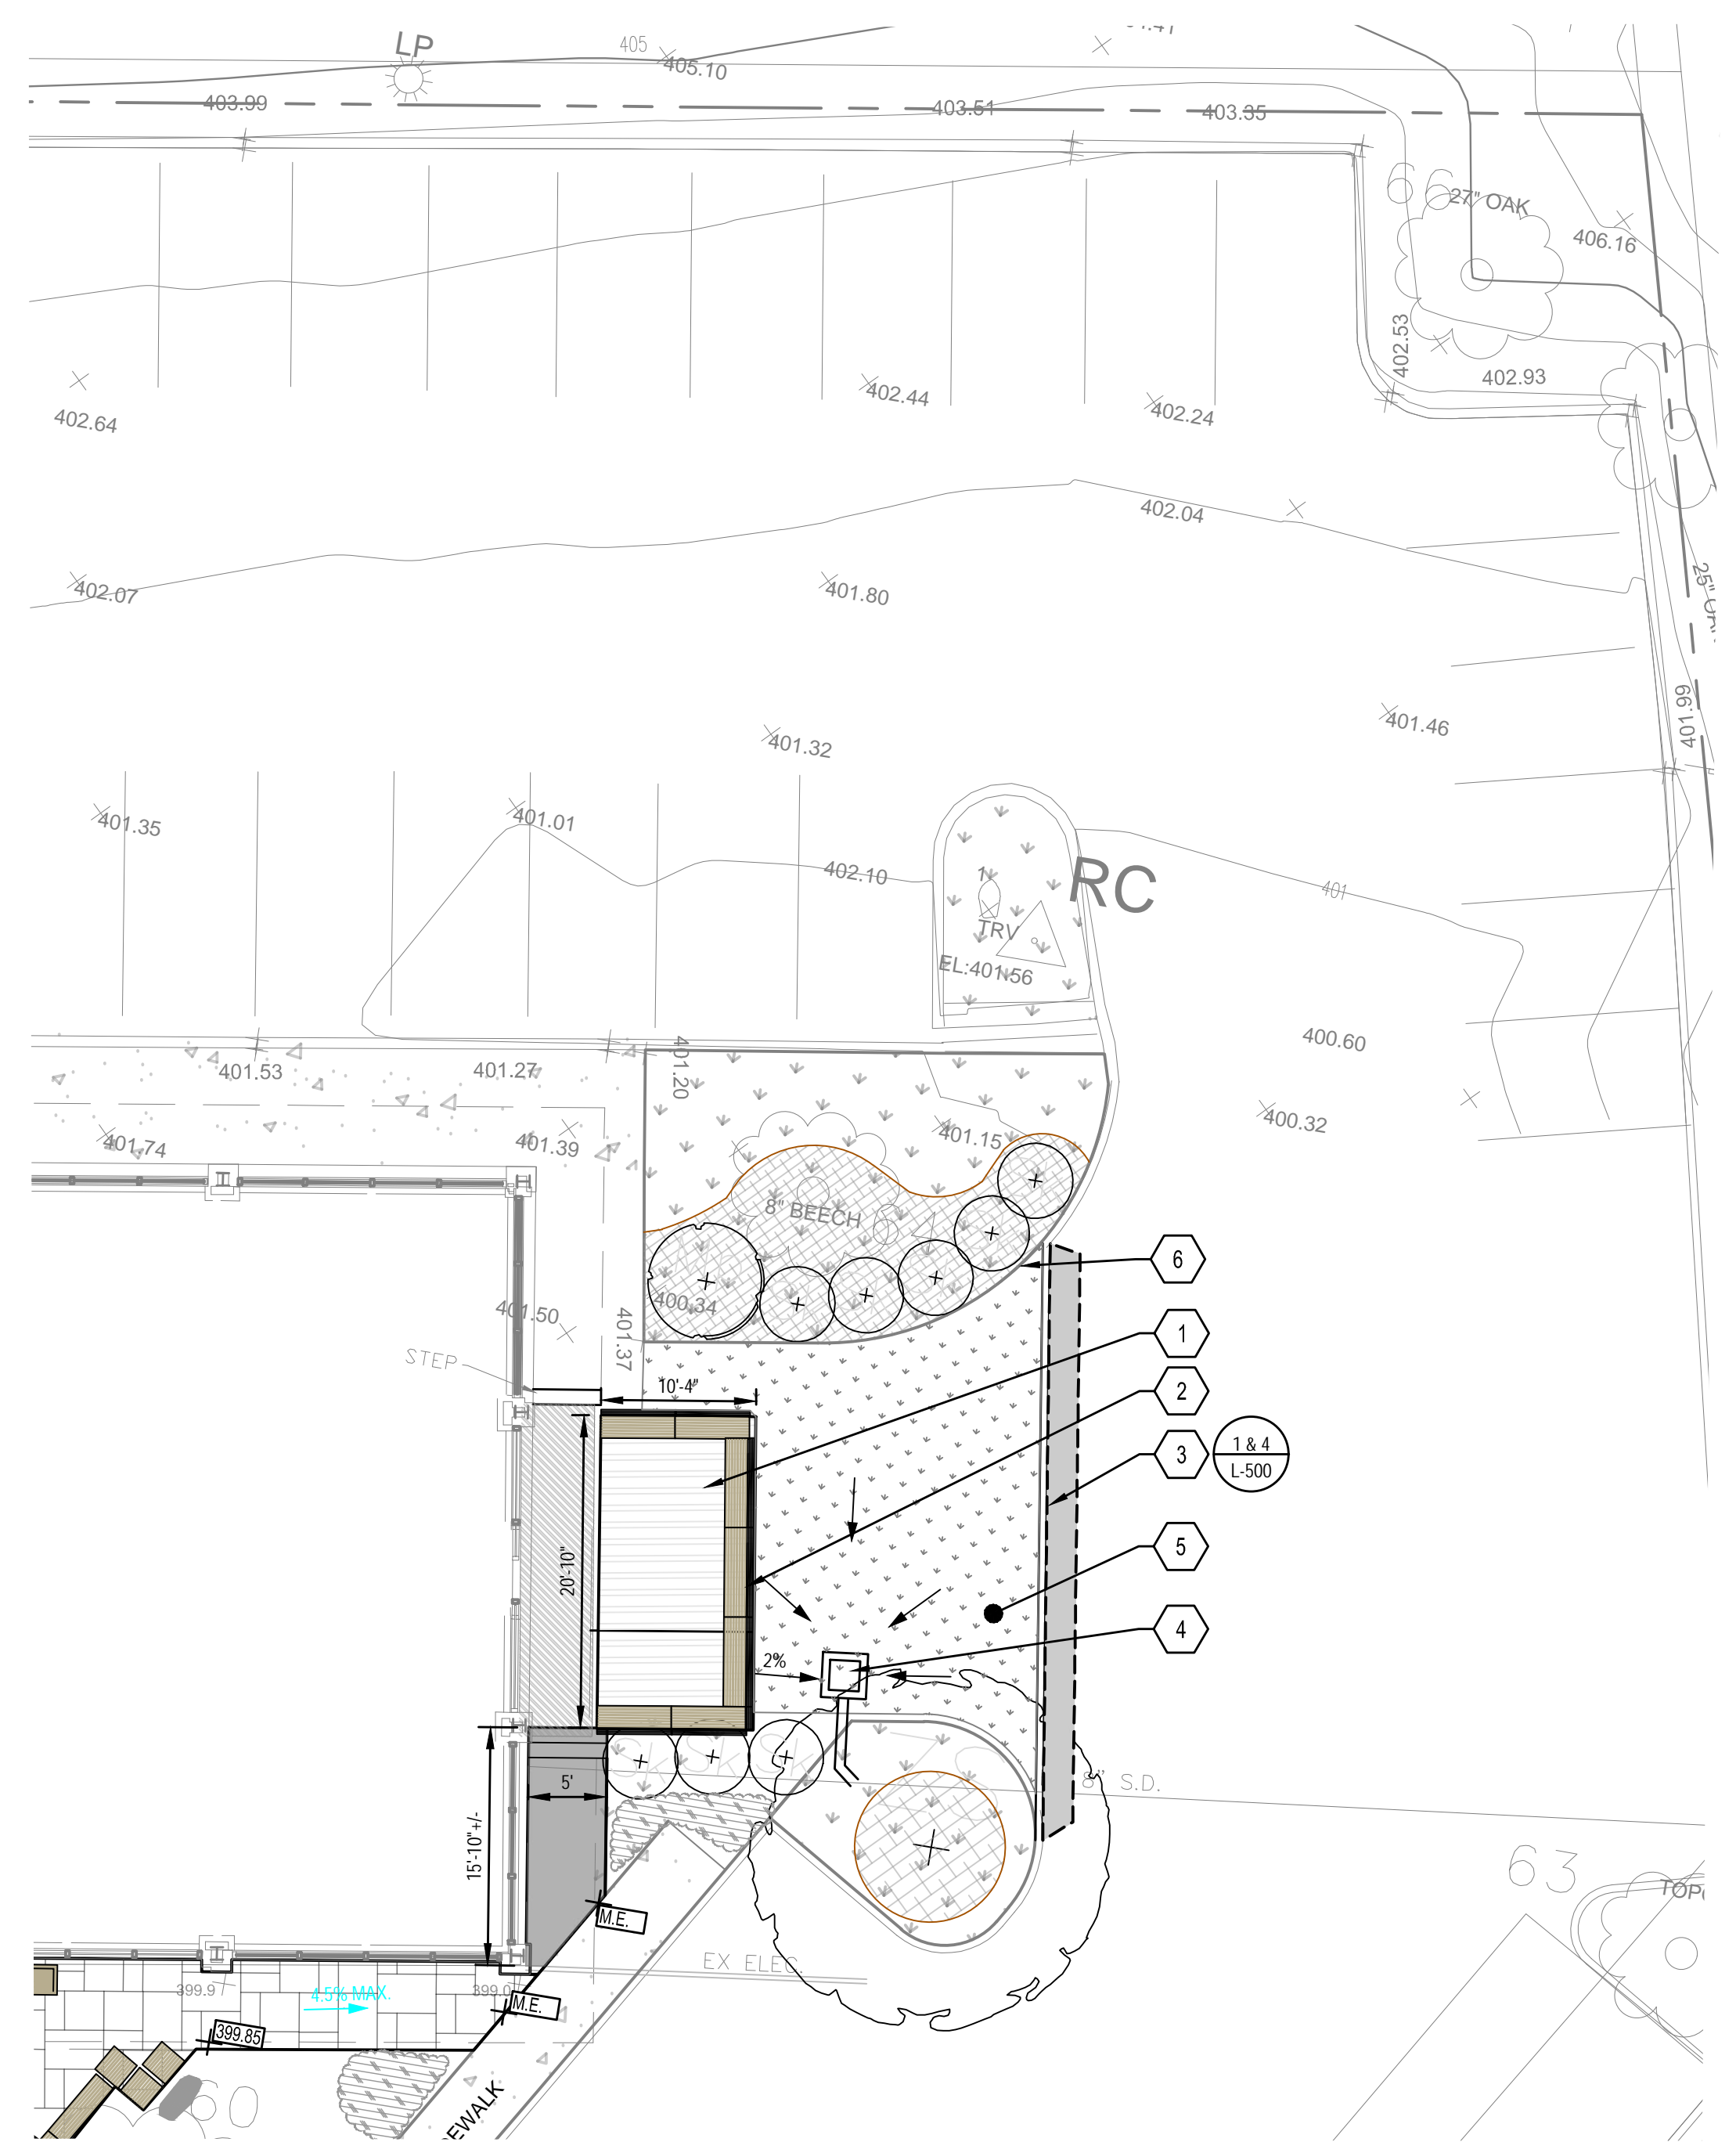


10 DETAIL PLAN (ADD ALTERNATE #1)
SCALE: 1" = 10'

1 LOADING DOCK DECK DETAIL (ADD ALTERNATE #1)
SCALE: NONE

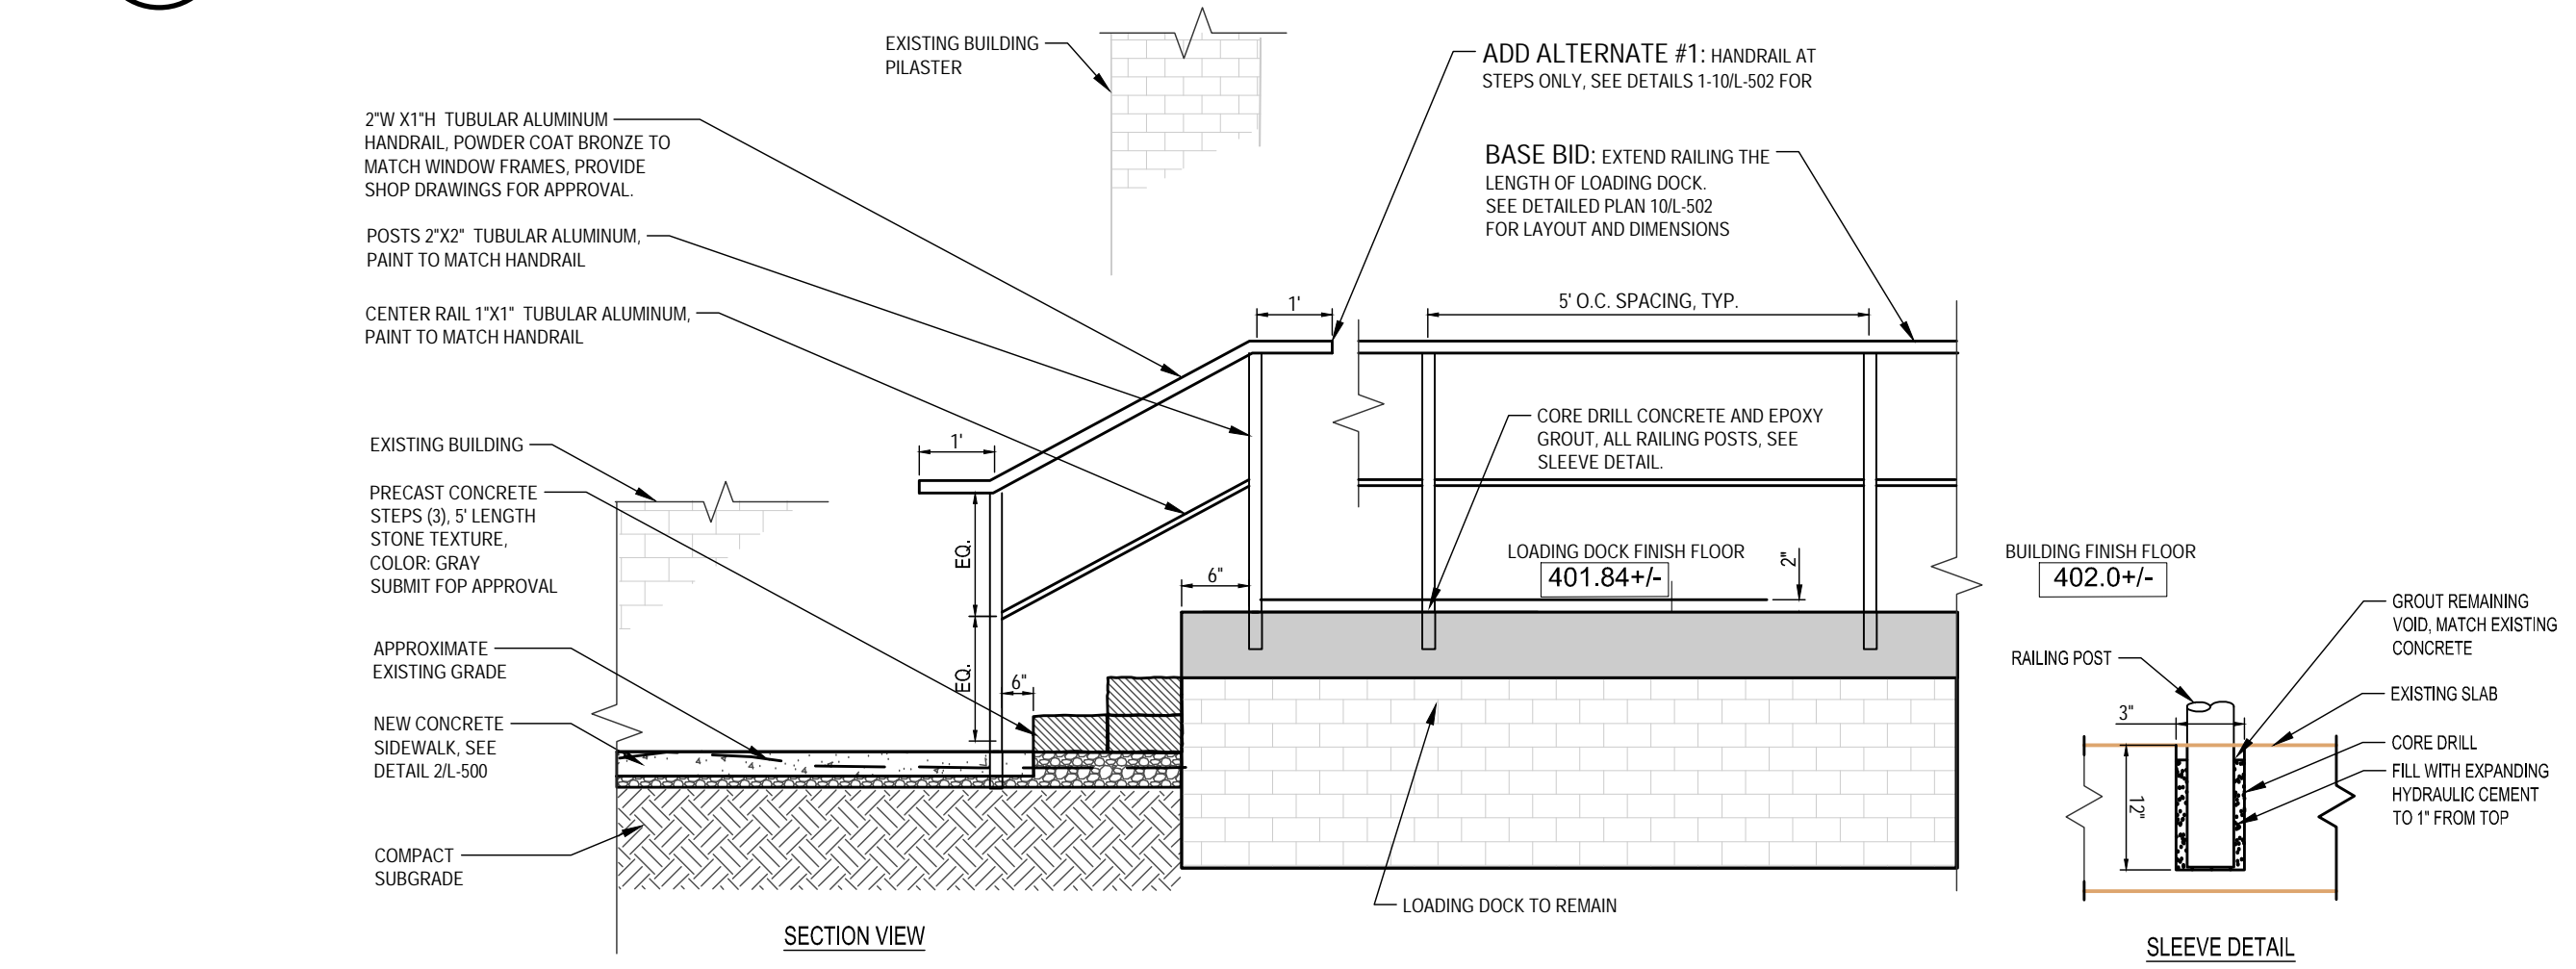

2 LOADING DOCK STEPS & RAILING DETAIL (BASE BID)
SCALE: NONE

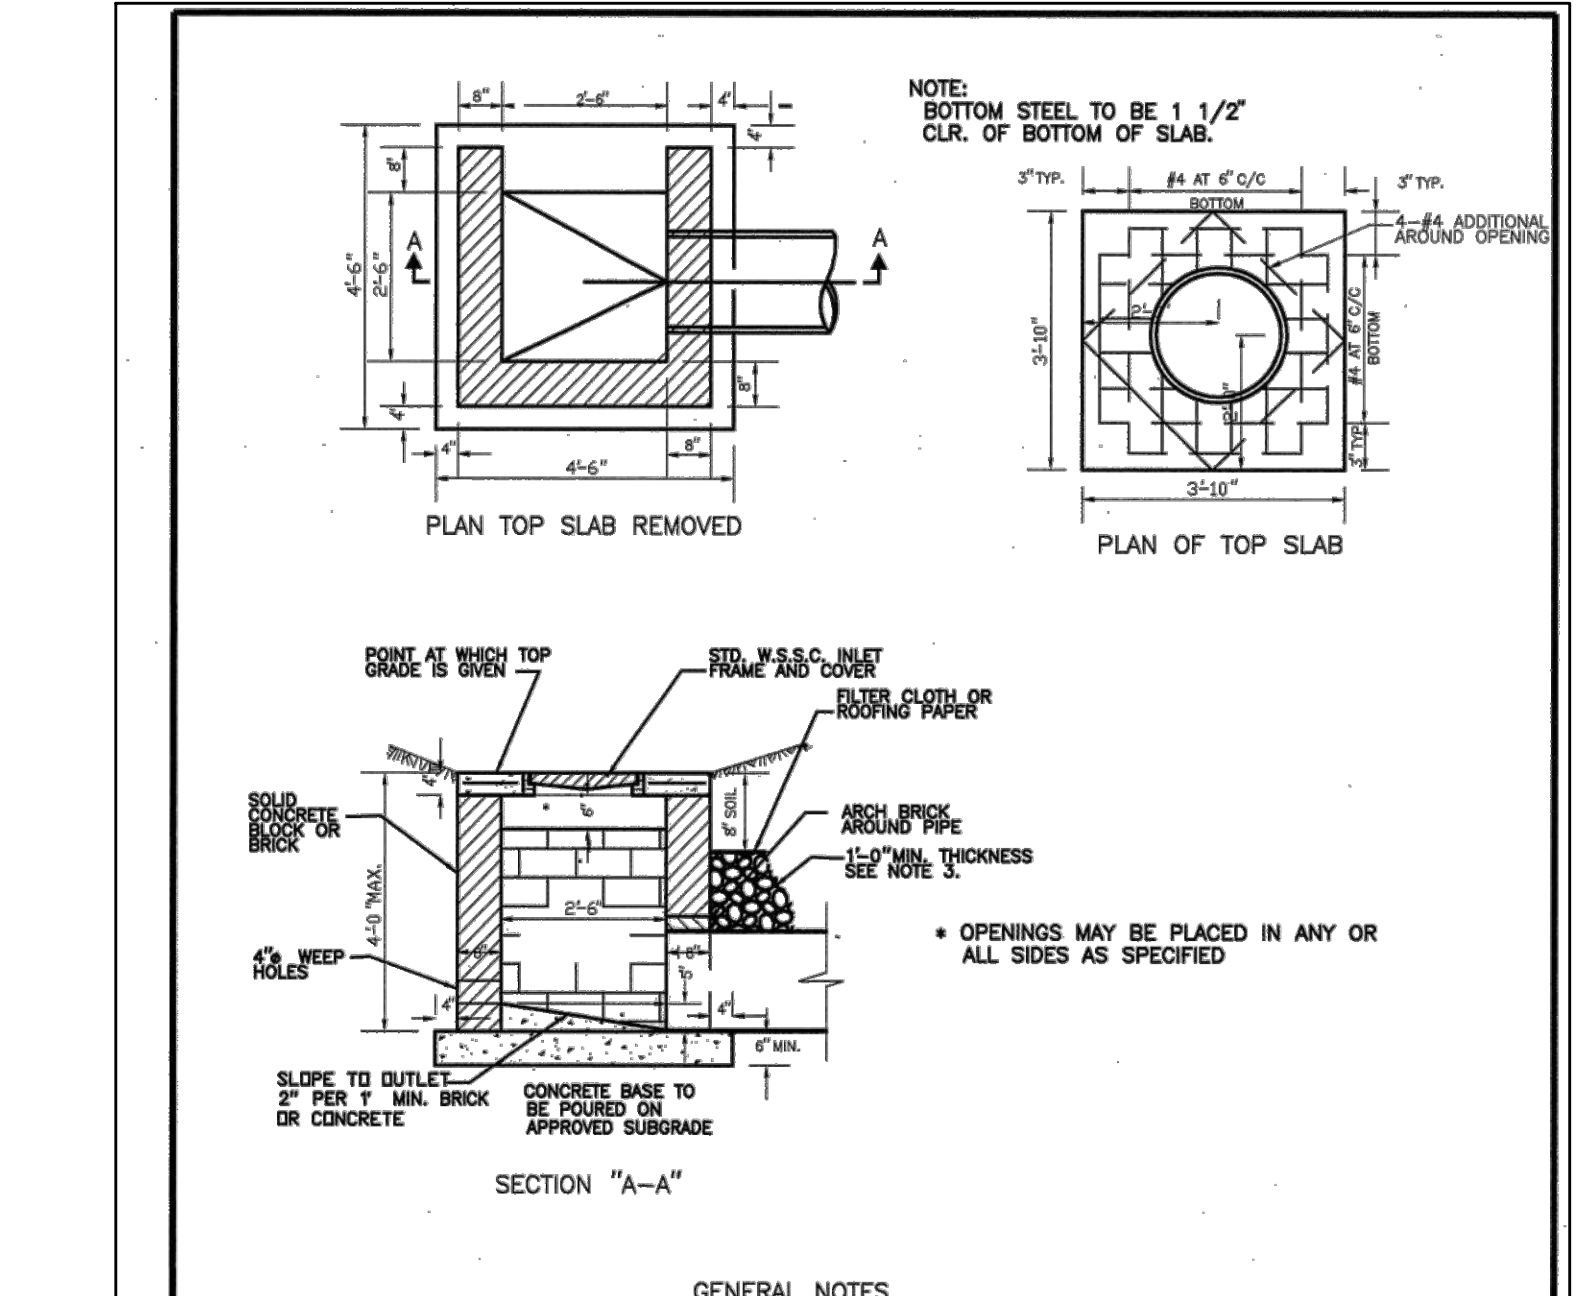

GENERAL NOTES:

- THIS STANDARD TO BE USED AS TERMINAL INLET ONLY.
- USE SOLID MASONRY (BRICK OR CONCRETE BLOCK) OR POURED CONCRETE FOR WALLS.
- INSTALL FOUNDATION DRAINAGE MATERIAL AROUND STRUCTURE FROM BOTTOM OF WEEP HOLES TO WITHIN 6" OF SURFACE, MIN. 1" FROM WALL.
- WEEP HOLES TO BE PLACED IN WALL OPPOSITE OUTLET PIPE 5" ABOVE PIPE INVERT. COVER OPENING WITH 1/2" HARDWARE CLOTH.
- MORTAR SHALL CONFORM TO ASTM SPECIFICATION C 270 TYPE M.
- REFER TO MARYLAND STATE HIGHWAY ADMINISTRATION FOR MATERIALS AND METHODS OF CONSTRUCTION.
- f' = 3,500 PSI AT 28 DAYS.

APPROVED	JAN 5 / 2018	REVISED	
MONTGOMERY COUNTY DEPARTMENT OF TRANSPORTATION			
"D" INLET			
STANDARD NO. MC-503.01			

30" X 30" PRECAST CONCRETE CATCH BASIN DETAIL (ADD ALTERNATE #1)
SCALE: NONE



APPROVED BY CITY OF ROCKVILLE, MD

DIRECTOR OF PUBLIC WORKS DATE
SEPARATE BUILDING PERMITS FROM INSPECTION SERVICES DIVISION ARE REQUIRED FOR ON-SITE CONSTRUCTION

Key Plan

SCALE: X" = XX' X"

No.	Revision	Date
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CITY OF ROCKVILLE 6 TAFT COURT RENOVATION		
ROCKVILLE MARYLAND		

DELTA
ENGINEERS, ARCHITECTS, & SURVEYORS

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Seal of the State of Maryland

Phase
IFB SUBMISSION

Project No.
2019.331.004

Date
2022.02.18

Drawing Title

LOADING DOCK DETAILS

Drawing No.

L-502